

GORMAN PARK

SITE AND PLAYGROUND IMPROVEMENTS

511 S 5TH STREET ST. PETER, MINNESOTA 56082

CONTEXT MAP





PROJECT DIRECTORY

OWNER

CITY OF SAINT PETER

PETE MOULTON, P.E. | CITY OF SAINT PETER DIRECTOR
OF PUBLIC WORKS
405 W. ST. JULIEN STREET
SAINT PETER, MINNESOTA 56082
PETEM@SAINTPETERMN.GOV
P: 507.934.0670

LANDSCAPE ARCHITECT

DAMON FARBER LANDSCAPE ARCHITECTS
310 S 4TH AVE
MINNEAPOLIS, MIN 55415
CONTACT: ABBY GLASTETTER, PLA
AGLASTETTER@DAMONFARBER.COM
314.413.7180

CIVIL ENGINEER

BOLTON & MENK
CONTACT: JEFFREY DOMRAS, P.E.
JEFFREYDOMRAS@BOLTON-MENK.COM

ELECTRICAL ENGINEER

NELSON-RUDIE & ASSOCIATES, INC. CONTACT: JEFFREY PIEHL, P.E. JEFFREY.IEHL@NELSONRUDIE.COM

	Sheet List Table
Sheet Nun	nber Sheet Title
GENERAL	SHEETS
G000	COVER SHEET
G001	GENERAL NOTES, ABBREVIATIONS & SYMBOLS
G002	LANDSCAPE NOTES
CIVIL SHE	ETS
C001	LEGEND
C002	EXISTING CONDITIONS
C003	REMOVAL PLAN
C101	TYPICAL SECTIONS & DETAILS
C102	TYPICAL SECTIONS & DETAILS
C105	MNDOT STANDARD PLANS
C106	MNDOT STANDARD PLANS
C201	STORMWATER POLLUTION PREVENTION PLAN
C202	STORMWATER POLLUTION PREVENTION PLAN
C203	STORMWATER POLLUTION PREVENTION PLAN
C204	STORMWATER POLLUTION PREVENTION PLAN
C205	STORMWATER POLLUTION PREVENTION PLAN
C301	SITE PLAN
C302	GRADING PLAN
C303	GRADING PLAN
C304	GRADING PLAN
C401	UTILITY PLAN
LANDSCAF	PE SHEETS
L000	SITE ORIENTATION PLAN
L001	SITE MATERIALS SCHEDULE
L002	SITE PLANTING SCHEDULE
L010	TREE PROTECTION PLAN
L011	TREE PROTECTION DETAILS
L100	SITE MATERIALS PLAN
L101	SITE MATERIALS ENLARGEMENT PLAN - PLAYGROUND
L103	SITE JOINTING & DIMENSIONING PLAN
L104	SITE JOINTING & DIMENSIONING PLAN ELARGEMENTS
L130	SITE SOILS - PLAN A
L131	SITE SOILS - PLAN B
L140	SITE TREE PLANTING PLAN
L141	SITE UNDERSTORY PLANTING - PLAN A
L142	SITE UNDERSTORY PLANTING - PLAN B
L150	SITE IRRIGATION PLAN
L400	SITE SECTION - PLAYGROUND CONTAINERS
L500	SITE DETAILS
L501	SITE DETAILS
L502	SITE DETAILS
L503	SITE DETAILS
L504	PLANTING DETAILS
ELECTRIC	AL SHEETS
E000	ELECTRICAL TITLE SHEET & SCHEDULES
E001	ELECTRICAL SITE PLAN
LPC1	LIGHTING PHOTOMETRIC CALCULATIONS



CITY OF SAINT PETER 227 South Front Street Saint Peter, MN 56082 p: 507.934.4840

DF/ DAMON FARBER LANDSCAPE ARCHITECTS

310 South 4th Avenue, Suite 7050 Minneapolis, MN 55415 p: 612.332.7522



BOLTON & MENK 1960 PREMIER DRIVE MANKATO, MN 56001-5900 p: 507.625.4171

IELSON-RUDIE NELSON-RUDIE 8

NELSON-RUDIE & ASSOCIATES 9100 49TH AVE NORTH MINNEAPOLIS, MN 55428 612.669.4385

> 100% CONSTRUCTION DRAWINGS

GORMAN PARK

ST. PETER, MINNESOTA

I hereby certify that this document was prepared by me or under my direct supervision and that I am a duly licensed Landscape Architect under the laws of the State of Minnesota.

Registration#	2629
Ton Office	12/24/202
Signature	Dat
100% CD SET	12/24/202
DF/ Project #	22-15
Scale	PER SHEE
Drawn/Checked	AG / RP / JR / JI
REVISION	

COVER SHEET

G000

GENERAL PROJECT NOTES

CONTRACT DOCUMENTS

- THE WORK SHALL CONFORM TO THE CONTRACT DOCUMENTS.
- THE CONTRACT DOCUMENTS ARE COMPLEMENTARY. READ THE DRAWINGS IN CONJUNCTION WITH THE SPECIFICATIONS AND
- THE WORK IS DEPENDENT ON SEVERAL DISCIPLINES. READ THE DRAWINGS BY CROSS-REFERENCING BETWEEN DISCIPLINES.
- REPORT DISCREPANCIES IMMEDIATELY TO THE OWNER'S REPRESENTATIVE FOR DIRECTION BEFORE PROCEEDING WITH THE

SITE ACCESS & PROTECTION

- STAGING AREA IS WITHIN THE CONTRACT LIMIT (OR "PROJECT LIMITS") LINE. STAGING AREA DOES NOT INCLUDE ACCESS ROUTES TO THE SITE. THE CONSTRUCTION (AND REMOVAL) OF TEMPORARY STAGING AREAS AND/OR ACCESS ROUTES SHALL BE THE CONTRACTOR'S SOLE RESPONSIBILITY AND EXPENSE.
- CONSTRUCTION RELATED VEHICLES REQUIRED FOR THE WORK EXITING AND/OR ENTERING THE SITE SHALL NOT DEPOSIT DIRT MUD, OR OTHER DELETERIOUS MATERIALS THAT WOULD PRESENT A NUISANCE OR HAZARD TO THE PUBLIC TRAVELING ON RIGHT OF WAYS. PREVENTION AND CLEANING SHALL BE THE CONTRACTOR'S SOLE RESPONSIBILITY AND EXPENSE.
- NO WORK, EQUIPMENT OR STAGING IS PERMITTED OUTSIDE THE LIMIT LINES UNLESS THE CONTRACTOR HAS APPROVAL FROM AUTHORITIES. COORDINATION PERMITS AND TRAFFIC CONTROL REQUIRED SHALL BE THE CONTRACTOR'S SOLE RESPONSIBILITY AND EXPENSE.
- THE DOCUMENTS DO NOT SPECIFY SAFETY MATERIALS, EQUIPMENT, METHODS OR SEQUENCING TO PROTECT PERSONS AND PROPERTY IT SHALL BE THE CONTRACTOR'S SOLE RESPONSIBILITY AND EXPENSE TO DIRECT AND IMPLEMENT SAFETY OPERATIONS TO PROTECT PERSONS AND PROPERTY.

QUALITY ASSURANCE

- EXECUTE THE WORK AND SCHEDULE INSPECTIONS IN ACCORDANCE WITH APPLICABLE FEDERAL, STATE, AND LOCAL STANDARDS, LAWS AND REGULATIONS
- ENSURE SUBCONTRACTORS, MANUFACTURERS AND SUPPLIERS HAVE THE LATEST CONTRACT DOCUMENTS PRIOR TO THE SUBMITTAL OF THEIR SHOP DRAWINGS AND/OR DELEGATED DESIGN
- REFER TO THE SPECIFICATIONS FOR REQUIRED SUBMITTALS, INSPECTIONS AND NOTICE TO PROCEED

EXISTING CONDITIONS SURVEY

- THE DOCUMENTS ARE BASED ON THE FOLLOWING TOPOGRAPHIC
 - TOPOGRAPHIC SURVEY BY BOLTON & MENK, INC. ON MAY 01,
- SURVEYED UNDERGROUND UTILITIES ARE PROVIDED FOR INFORMATION ONLY AS THEY ARE INFERRED BY SURFACE MARKINGS AND FEATURES AND AS SUCH MAY NOT BE ACCURATE OR

THE GEOTECHNICAL REPORTS ARE MADE AVAILABLE FOR INFORMATION ONLY AS SOME RECOMMENDATIONS IN THE REPORT MAY NOT BE RELEVANT OR USED IN THE DOCUMENTS

- THE LOCATIONS AND SIZES OF EXISTING UTILITIES (IF SHOWN) ARE APPROXIMATE ONLY, IDENTIFY, LOCATE AND PROTECT UNDERGROUND AND OVERHEAD UTILITIES TO REMAIN
- COORDINATE WITH THE LOCAL UTILITY COMPANIES AND/OR AGENCIES. CALL LOCAL '811' OR REQUEST LOCATES ONLINE NO. LESS THAN 48 HOURS PRIOR TO DIGGING TO LOCATE UNDERGROUND UTILITIES OR AS REQUIRED BY LOCAL
- BE FULLY RESPONSIBLE FOR THE COST OF DAMAGES WHICH OCCUR AS A RESULT OF A FAILURE TO ACCURATELY LOCATE AND/OR RETAIN UTILITIES TO REMAIN.

LAYOUT

- THE VERTICAL CONTROL FOR THE PROJECT IS: NORTH AMERICAN VERTICAL DATUM (NAV88) OR NATIONAL GEODETIC DATUM (NGDV29) UNLESS OTHERWISE NOTED
- VERIFY THE LOCATION OF EXISTING FEATURES TO REMAIN THAT CONNECT TO NEW WORK, DIMENSIONAL CLEARANCES, SETBACKS AND OFFSETS AND VERTICAL DATUM. REPORT DISCREPANCIES. IMMEDIATELY TO THE OWNER'S REPRESENTATIVE FOR DIRECTION BEFORE PROCEEDING WITH THAT PORTION OF THE WORK
- VERIFY PREVIOUS UNDERLYING TRADEWORK CONFORMS TO THE DOCUMENTS PRIOR TO PROCEEDING WITH OVERLYING TRADEWORK. REPORT DISCREPANCIES IMMEDIATELY TO THE OWNER'S REPRESENTATIVE FOR DIRECTION BEFORE PROCEEDING WITH THAT PORTION OF THE WORK.
- GENERAL CONTRACTOR SHALL RETAIN SURVEY CONTROL FOR LAYOUT OF THE WORKS AND AS-BUILT SURVEYS.
- COORDINATE AND COLLATE SUBCONTRACTOR'S SURVEYS. IT IS THE CONTRACTOR'S RESPONSIBILITY TO FIELD VERIFY EXISTING SITE CONDITIONS AND EVOLVING SITE CONDITIONS PRIOR TO THE START OF SITE WORK, DISCREPANCY AND/OR UNFORESEEN CONDITIONS FOUND SHALL BE BROUGHT TO THE IMMEDIATE ATTENTION OF THE OWNER'S REPRESENTATIVE PRIOR TO STARTING THE SITE WORK.

- DO NOT BEGIN WORK IN SUCH AFFECTED AREA UNTIL THE DISCREPANCY HAS BEEN RESOLVED
- ERECT AND INSTALL ALL WORK LEVEL, PLUMB, SQUARE, TRUE STRAIGHT AND IN PROPER ALIGNMENT
- 7. DO NOT SCALE FROM DRAWINGS. USE DIMENSIONS SHOWN AND/OR SUPPLIED CAD DRAWING FILE AND SURVEY INTERPOLATION.
- 8 DIMENSIONS NOTED "CLR" OR "CLEAR" MUST BE STRICTLY MAINTAINED ALLOWING FOR THICKNESS OF FINISHES. FIELD VERIEY
- ANGLES ARE 90 DEGREES UNLESS NOTED OTHERWISE.

PRIOR TO CONSTRUCTION.

- 10. CURVES FOR PAVING BANDS PATHS EDGING AND HEADER BOARDS SHALL BE SMOOTH AND CONTINUOUS WITHOUT ABRUPT CHANGES, OBVIOUS TANGENTS OR BENDS.
- 11. PITCH EVENLY BETWEEN SPOT GRADES AND CONTOUR LINES UNLESS GRADE BREAKS, RIDGELINES, SWALES ARE INDICATED OF OTHERWISE NOTED. PAVED AREAS SHALL PITCH AT A MINIMUM OF 1% UNLESS OTHERWISE NOTED ON DRAWINGS, DISCREPANCIES OR CONDITIONS NOT ALLOWING THIS TO OCCUR SHALL BE REPORTED TO THE OWNER'S REPRESENTATIVE FOR RESOLUTIONS PRIOR TO CONTINUING WORK
- 12. PEDESTRIAN SIDEWALKS AND PAVING SHALL HAVE A CROSS PITCH LESS THAN 2% UNLESS OTHERWISE NOTED TO MEET ADA REQUIREMENTS
- 13 REQUEST A FIELD REVIEW BY THE LANDSCAPE ARCHITECT OF THE LAYOUT OF ELEMENTS AS SHOWN. OBTAIN LANDSCAPE ARCHITECT'S APPROVAL OF LAYOUT BEFORE INSTALLING THE
- FIRST TYPICAL SITE LIGHTING FIXTURES, JUNCTION BOXES,
- FIRST TYPICAL SITE UTILITY FIXTURES, INCLUDING BUT NOT LIMITED TO BOXES VAULTS PULL BOXES MAN HOLES AIR RELEASE VALVES, VENTS, BFP, AND OTHER CIVIL, MECHANICAL ELECTRICAL, PLUMBING, TELECOM, HEATING/COOLING, AND **IRRIGATION STRUCTURES**
- . FIRST TYPICAL FORMWORK OF WALLS.
- TREE LOCATIONS. STAKE ALL TREE LOCATIONS. OBTAIN APPROVAL OF LANDSCAPE ARCHITECT BEFORE PLANTING TREES.
- FIRST TYPICAL CURVED EDGING AND CUTTING.
- FIRST TYPICAL EXPANSION JOINTS IN CONCRETE PAVING.

WORK BY OTHERS

- COOPERATE AND COORDINATE WITH OTHER CONTRACTORS WORKING CONCURRENTLY SO AS TO NOT VIOLATE EACH OTHER'S PERMITS AND TO AVOID DAMAGE TO EACH OTHER'S WORK
- 2. EACH CONTRACTOR SHALL PROTECT AND MAINTAIN THEIR OWN WORK FOR THE DURATION OF THEIR CONTRACTS.

CODE COMPLIANCE

- WORK SHALL BE IN ACCORDANCE WITH APPLICABLE LAWS, CODES AND REQUIREMENTS OF REGULATORY AGENCIES HAVING JURISDICTION.
- NOTIFY THE OWNER'S REPRESENTATIVE OF DISCREPANCIES BETWEEN THE WORK AND APPLICABLE CODES. DO NOT WORK IN AN AFFECTED AREA UNTIL THE DISCREPANCY HAS BEEN RESOLVED.
- VERIFY CODES IN EFFECT AT THE TIME OF THE NOTICE TO PROCEED AND STAY CURRENT WITH CODE CHANGES WHICH AFFECT THE WORK UNTIL SUBSTANTIAL COMPLETION.
- 4. IT IS THE SOLE RESPONSIBILITY OF THE CONTRACTOR TO OBTAIN

CODES IN EFFECT

- THE FOLLOWING CODES ARE APPLICABLE AND IN EFFECT
- CODE OF ORDINANCES CITY OF SAINT PETER MINNESOTA CODIFIED THROUGH ORDINANCE NO. 57(3RD SER.), ADOPTED DECEMBER 12, 2022. (SUPP. NO. 14)
- 2 REVISIONS TO THE APPROVED AND PERMITTED DRAWINGS OR DOCUMENTS SHALL BE SUBMITTED TO THE CODE AUTHORITIES FOR REVIEW. NOTIFY THE OWNER'S REPRESENTATIVE OF THE PROCESSING TIME FOR EACH REVISION SUBMITTED FOR PLAN

COPYRIGHT AND REPRODUCTION

- THE USE OF REPRODUCTIONS OF THE CONTRACT DOCUMENTS OR ELECTRONIC EILES AS SHOP DRAWING DOCUMENTS BY THE CONTRACTOR IS AT THEIR OWN RISK. THE DESIGN CONSULTANTS ASSUME NO LIABILITY AS A RESULT OF THE USE OF REPRODUCTIONS OF THE CONTRACT DOCUMENTS FOR SHOP DRAWINGS AND/OR DELEGATED DESIGN DRAWINGS.
- 2. THE ENTIRE CONTRACT DOCUMENT PACKAGE HEREIN IS THE ORIGINAL AND UNPUBLISHED PROPERTY OF THE OWNER AND MAY NOT BE DUPLICATED, USED OR DISCLOSED WITHOUT THE PRIOR EXPLICIT WRITTEN CONSENT
- THE USE OF DIGITAL DESIGN FILES SHALL REQUIRE THE CONTRACTOR TO AGREE TO PRIME CONSULTANT'S LICENSE CONDITIONS BEFORE USE.

CONSTRUCTION LOADS, DAMAGES & REPAIRS

- THE CONTRACTOR IS SOLELY RESPONSIBLE FOR SLOPE STABILITY AND DE-WATERING DURING THE WORKS UNLESS UNKNOWN CONDITIONS ARE ENCOUNTERED.
- THE CONTRACTOR IS SOLELY RESPONSIBLE FOR PROTECTING THE WORKS FROM CONSTRUCTION LOADS AND DAMAGES TO EXISTING STRUCTURES TO REMAIN, NEW STRUCTURES AND NEW PAVEMENTS DURING THE WORKS


3 BE FULLY RESPONSIBLE FOR THE COST OF DAMAGES WHICH OCCUR AS A RESULT OF A FAILURE TO MITIGATE CONSTRUCTION LOADS AND/OR PROTECT THE WORKS FROM CONSTRUCTION RELATED IMPACTS. REPAIRS SHALL BE TO A NEW OR BETTER CONDITION COMPARED TO THE EXISTING CONDITION BEFORE DAMAGE, AND AS APPROVED BY THE OWNER'S REPRESENTATIVE.

4. CONFIRM ON-STRUCTURE UNIFORM AND POINT LOAD LIMITS WITH ENGINEER PRIOR TO IMPORTING AND HANDLING LANDSCAPE MATERIALS OVER VAULTS, AND/OR TUNNELS, INCLUDING UTILITY STRUCTURES, AND FLOOD CONTROL STRUCTURES

CONSTRUCTION WASTE MANAGEMENT

REMOVE FROM THE SITE EXCESS MATERIAL AND/OR DEBRIS. DISPOSAL OF MATERIALS IS THE RESPONSIBILITY OF THE CONTRACTOR. EXCESS MATERIAL AND/OR DEBRIS TO ABLE TO BE RECYCLED OR REUSED SHALL BE DISPOSED OF OFF THE PROJECT SITE IN A PERMITTED LANDFILL.

SYMBOLS

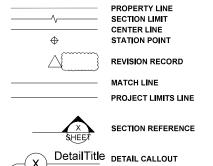



LARGE SCALE PLAN OR **ENLARGED DETAIL**

LEADER

DIMENSION



DIMENSION (RADIUS, ANGLE FOCI



DIMENSION (ARC LENGTH)



ALIGN

KEY NOTE



DEG DIA DIAMETER DIN DIMENSION DIST DISTANCE DIVISION DWG DRAWING EAST **EXPANSION JOINT** EJ ELEVATION EDGE OF PAVEMEN EQ EQS EQUAL SPACING EQUIV **EQUIVALENT** EXISTING EX **FAHRENHEIT** FOOTCANDLE FC FFE FINISH FLOOR ELEVATION FF&E **FINISHED GRADE** FG FOC FACE OF CURB **FACE OF WALL** FOW F۷ FIELD VERIFY GALV GALVANIZED GDR GUARDRAIL HIGH HOSE BIBB HB HIGH DENSITY POLYETHYLENE HDPE нн HAND HOLE HDR HANDRAIL HORIZ HORIZONTAL HT HEIGHT HV HIGH VOLTAGE ID INSIDE DIMENSION INV.EL INVERT ELEVATION κw KILOWATT I DPF LOW DENSITY POLYETHYLENE

ABBREVIATIONS

APPROXIMATE

AVERAGE

BUILDING

воттом

BENCHMARK

BOTTOM OF STAIR

APPROX

AVG

BLDG

BM

BOS

BOT

С

CB

CIE

CJ

CI

CLR

CLL

CMU

CTR

DAT

CHILLER PRCST CATCH BASIN CAST-IN-PLACE CONTROL JOINT CENTER LINE CLEAR CONTRACT LIMIT LINE CONCRETE MASONRY UNIT CONC CONCRETE CENTER DATUM DEGREE FURNITURE, FIXTURE, AND EQUIPMENT

LED LIGHT EMITTING DIODE I INFAR FEET LPT LOW POINT LIMITED LTD LV LOW VOLTAGE LOW WATER MAYIMIIM MANUFACTURER'S RECOMMENDATIONS

LW MAY MFR.REC MANHOLE MID MIDDLE MIN MINIMUM NORTH NA NOT APPLICABLE NIC NOT IN CONTRACT

NTS NOT TO SCALE ОС ON CENTER **OUTSIDE DIAMETER** OVERHANG

NUMBER

NOMINAL

PULL BOX

NO

NOM

POINT OF CURVE PRECAST CONCRETE PERFORATED PFRF PERP PERPENDICULAR ACID/ALKALINE SCALE PHASE POINT OF INTERSECTION PACKAGE

PC

РΗ

ы

PKG

PLBG

PROV

PVC

QTR

QTY

RECIRC

RECPT

REINE

REQD

REV

RLG

ROW

SALV

SEG

SHT

SIM

SQ

SSD

SST

STA

STD

SUCT

TAN

TRD

TD

TEMP

THK

THRII

TO_

TOC

TOL

TOS

TOW

TS

TYP

UGND

UV

VAR

VERT

VRFY

W/O

WL

WLD

WT.EL

XFME

YR

-/+

IJ

нw

TB-XX

SPEC

PREFAB

PCC

PROPERTY LINE PLUMBING PRECAST PREFABRICATE PROVISIONAL POLYVINYL CHLORIDE

QUARTER QUANTITY **RADIUS**

REINFORCED CONCRETE PIPE RECIRCULATE RECEPTACLE REINFORCE REQUIRED REVISION RAILING RIGHT OF WAY

SOUTH SALVAGE SEGMENT SHEET SIMIL AR SPECIFICATION SQUARE SUBSOIL DRAIN STAINLESS STEEL STATION STANDARD SUCTION TRANSFORMER TANGENT

TO BE DETERMINED TEST BORING TRENCH DRAIN TEMPORARY THICKNESS THROUGH TOP OF TOP OF CURB TOLERANCE TOP OF SLOPE TOP OF WALL TRASH TOP OF STAIR TYPICAL

UNDERGROUND UTILITY POLE ULTRAVIOLE' VARIES

VERTICAL VERIFY WEST WITH WITHOUT WATERLINE WELDED WATER ELEVATION

TRANSFORMER

YEAR AND DIMENSION TOLERANCE

ISOLATION JOIN HIGH WATER NORMAL POOL

GRADE BREAK

CITY OF

CITY OF SAINT PETE Saint Peter MN 56082 p: 507.934.4840

DAMON FARBER LANDSCAPE ARCHITECTS 310 South 4th Avenue, Suite 7050

Minneapolis, MN 55415 p: 612.332.7522 **BOLTON**



NELSON-RUDIE & ASSOCIATES 9100 49TH AVE NORTH

MINNEAPOLIS, MN 55428

p: 507.625.4171

612,669,4385

MANKATO, MN 56001-5900

CONSTRUCTION DRAWINGS

GORMAN PARK

ST. PETER, MINNESOTA

I hereby certify that this document was ртератец by me or under my direct supervision and that I am a duly licensed Landscape Architect under the laws of the State of Minnesota

Registration# 12/24/2024 12/24/2024 100% CD SET DF/ Project # 22-150 PER SHEET AG / RP / JR / JN Drawn/Checked REVISION

GENERAL ABBREVIATIONS & SYMBOLS

EXISTING CONDITIONS & SITE REMOVAL NOTES

SITE SPECIFIC NOTES

- EXISTING TREEMENDOUS PLAYGROUND TO REMAIN OPEN TO PUBLIC THROUGHOUT PHASE 1 CONSTRUCTION.
- 2. ALL TREES MARKED AS DEMO TO BE CLEARED AND GRUBBED WITH STUMPS BEING GROUND 36" BELOW FINISHED GRADE.
- 3. TRACK PADS OR LANDSCAPE ARCHITECT APPROVED ALTERNATE TO BE USED THROUGHOUT SITE IF CONSTRUCTION EQUIPMENT IS BEING USED BELOW EXISTING TREE DRIPLINES.

SITE REMOVAL NOTES

- EXISTING SITE INFORMATION WAS PROVIDED BY OTHERS, ACTUAL FIELD CONDITIONS MAY VARY, FIELD VERIFY UTILITY LOCATIONS AND ELEVATIONS PRIOR TO CONSTRUCTION.
- 2. THE LOCATIONS OF EXISTING UTILITIES SHOWN ON THIS PLAN HAVE BEEN DETERMINED FROM THE BEST INFORMATION AVAILABLE AND ARE GIVEN FOR THE CONVENIENCE OF THE CONTRACTOR. THE LANDSCAPE ARCHITECT ASSUMES NO RESPONSIBILITY FOR THEIR ACCURACY. PRIOR TO THE START OF DEMOLITION ACTIVITY, THE CONTRACTOR SHALL NOTIFY THE UTILITY COMPANIES FOR ONSITE LOCATIONS OF EXISTING UTILITIES. THE CONTRACTOR IS REQUIRED TO TAKE DUE PRECAUTIONARY MEASURES TO PROTECT EXISTING UTILITIES OR STRUCTURES LOCATED AT THE WORK SITE.
- CONTRACTOR TO VERIFY THE LOCATION OF UNDERGROUND UTILITIES PRIOR TO BEGINNING ANY CONSTRUCTION BY CALLING GOPHER STATE ONE-CALL AT 651-454-0002 (METRO) OR 1-800-252-1166 (OUT-STATE).
- 4. THE CONTRACTOR SHALL COORDINATE WITH RESPECTIVE UTILITY COMPANIES PRIOR TO THE REMOVAL AND/OR RELOCATION OF UTILITIES. THE CONTRACTOR SHALL COORDINATE WITH THE UTILITY COMPANY CONCERNING PORTIONS OF WORK WHICH MAY BE PERFORMED BY UTILITY COMPANY'S FORCES AND FEES WHICH ARE TO BE PAID TO THE UTILITY COMPANY FOR THEIR SERVICES. THE CONTRACTOR IS RESPONSIBLE FOR PAYING FEES AND CHARGES.
- 5. ALWAYS VERIFY BENCHMARK ELEVATIONS BETWEEN TWO BENCHMARKS.
- 6. REMOVAL ITEMS BECOME THE PROPERTY OF THE CONTRACTOR UNLESS SPECIFIED OTHERWISE. THE CONTRACTOR IS RESPONSIBLE FOR REMOVING DEBRIS FROM THE SITE AND DISPOSING THE DEBRIS IN A LAWFUL MANNER PER LOCAL GOVERNING AGENCIES. THE CONTRACTOR IS RESPONSIBLE FOR OBTAINING PERMITS REQUIRED FOR DEMOLITION AND DISPOSAL. FACILITIES TO BE REMOVED SHALL BE UNDERCUT TO SUITABLE MATERIAL AND BROUGHT TO GRADE WITH SUITABLE COMPACTED FILL MATERIAL PER THE SPECIFICATIONS.
- 7. PRIOR TO DEMOLITION, EROSION CONTROL DEVICES ARE TO BE INSTALLED WHERE NECESSARY AND OBTAIN AN NPDES STORM WATER PERMIT. REFER TO CIVIL FOR EROSION CONTROL.
- 8. DAMAGE TO REMAINING EXISTING CONDITIONS WILL BE REPLACED AT CONTRACTOR'S EXPENSE AND SHALL BE EQUAL TO OR EXCEED THE QUALITY OF CONSTRUCTION PRIOR TO DAMAGE.
- 9. CONCRETE PAVEMENT, SIDEWALKS, CURB AND GUTTER, AND OTHER POURED CONCRETE ITEMS ARE TO BE REMOVED TO AN EXISTING EXPANSION OR CONTRACTION JOINT.
- 10. CONTRACTOR SHALL LIMIT SAW-CUT AND PAVEMENT REMOVAL TO ONLY THOSE AREAS WHERE IT IS REQUIRED AS SHOWN ON THESE CONSTRUCTION PLANS. IF DAMAGE IS INCURRED ON THE SURROUNDING PAVEMENT, ETC. THE CONTRACTOR SHALL BE RESPONSIBLE FOR ITS REMOVAL AND REPAIR AT NO ADDITIONAL COST TO THE OWNER. BITUMINOUS PAVEMENT REMOVALS ARE TO BE MADE WITH A VERTICAL SAW CUT OR TO A NEAT MILLED EDGE.
- 11. CONTRACTOR SHALL PRESERVE VEGETATION NOT TO BE REMOVED BY CONSTRUCTION. CONTRACTOR SHALL BE RESPONSIBLE FOR RE-SEEDING OR SODDING AREAS DISTURBED BY CONSTRUCTION.
- 12. LOCATION AND ELEVATIONS OF IMPROVEMENTS TO BE MET (OR AVOIDED) SHALL BE CONFIRMED BY THE CONTRACTOR THROUGH FIELD EXPLORATIONS PRIOR TO CONSTRUCTION. CONTRACTOR SHALL REPORT TO THE LANDSCAPE ARCHITECT DISCREPANCIES BETWEEN THEIR MEASUREMENTS AND THESE PLANS. CONTRACTOR SHALL ALSO MAKE EXPLORATION EXCAVATIONS AND LOCATE EXISTING UNDERGROUND UTILITIES SUFFICIENTLY AHEAD OF CONSTRUCTION TO PERMIT REVISIONS TO PLANS IF REVISIONS ARE NECESSARY BECAUSE OF ACTUAL LOCATION OF EXISTING FACILITIES. CONTRACTOR IS REQUIRED TO TAKE PRECAUTIONARY MEASURES TO PROTECT THE UTILITY LINES SHOWN AND OTHER EXISTING LINES NOT OF RECORD OR NOT SHOWN ON THESE PLANS.
- EXISTING UTILITIES TO REMAIN IN PLACE UNLESS SPECIFICALLY MARKED ON THIS SHEET.

SITE AND LANDSCAPE NOTES

SITE PREPARATION NOTES

- CONTRACTOR SHALL INSPECT THE SITE AND BECOME FAMILIAR
 WITH EXISTING CONDITIONS RELATING TO THE NATURE AND SCOPE
 OF WORK
- CONTRACTOR SHALL VERIFY PLAN LAYOUT AND BRING TO THE
 ATTENTION OF THE LANDSCAPE ARCHITECT DISCREPANCIES WHICH
 MAY COMPROMISE THE DESIGN OR INTENT OF THE LAYOUT.
- 3. CONTRACTOR SHALL ASSURE COMPLIANCE WITH APPLICABLE CODES AND REGULATIONS GOVERNING THE WORK AND MATERIALS SUPPLIED.
- 4. CONTRACTOR SHALL PROTECT EXISTING ROADS, CURBS/GUTTERS, TRAILS, TREES, LAWNS AND SITE ELEMENTS DURING CONSTRUCTION OPERATIONS. DAMAGE TO SAME SHALL BE REPAIRED AT NO ADDITIONAL COST TO THE OWNER.
- CONTRACTOR SHALL VERIFY ALIGNMENT AND LOCATION OF UNDERGROUND AND ABOVE GRADE UTILITIES AND PROVIDE THE NECESSARY PROTECTION FOR SAME BEFORE CONSTRUCTION BEGINS (MINIMUM 10' CLEARANCE).
- CONTRACTOR SHALL COORDINATE THE PHASES OF CONSTRUCTION AND PLANTING INSTALLATION WITH OTHER CONTRACTORS
 WORKING ON SITE
- 7. UNDERGROUND UTILITIES SHALL BE INSTALLED SO THAT TRENCHES DO NOT CUT THROUGH ROOT SYSTEMS OF EXISTING TREES TO PEMAIN
- 8. EXISTING CONTOURS, TRAILS, VEGETATION, CURB/GUTTER AND OTHER ELEMENTS ARE BASED UPON INFORMATION SUPPLIED TO THE LANDSCAPE ARCHITECT BY OTHERS. CONTRACTOR SHALL VERIFY DISCREPANCIES PRIOR TO CONSTRUCTION AND NOTIFY LANDSCAPE ARCHITECT OF SAME.
- 9. HORIZONTAL AND VERTICAL ALIGNMENT OF PROPOSED WALKS, TRAILS OR ROADWAYS ARE SUBJECT TO FIELD ADJUSTMENT REQUIRED TO CONFORM TO LOCALIZED TOPOGRAPHIC CONDITIONS AND TO MINIMIZE TREE REMOVAL AND GRADING. CHANGES IN ALIGNMENT AND GRADES MUST BE APPROVED BY THE LANDSCAPE ARCHITECT PRIOR TO IMPLEMENTATION.
- 10. CONTRACTOR SHALL REVIEW THE SITE FOR DEFICIENCIES IN SITE CONDITIONS WHICH MIGHT NEGATIVELY AFFECT PLANT ESTABLISHMENT, SURVIVAL OR WARRANTY. UNDESIRABLE SITE CONDITIONS SHALL BE BROUGHT TO THE ATTENTION OF THE LANDSCAPE ARCHITECT PRIOR TO COMMENCEMENT OF WORK.
- 11. CONTRACTOR IS RESPONSIBLE FOR ONGOING MAINTENANCE OF NEWLY INSTALLED MATERIALS UNTIL TIME OF SUBSTANTIAL COMPLETION. REPAIR OF ACTS OF VANDALISM OR DAMAGE WHICH MAY OCCUR PRIOR TO SUBSTANTIAL COMPLETION SHALL BE THE RESPONSIBILITY OF THE LANDSCAPE CONTRACTOR.
- 12. EXISTING TREES OR SIGNIFICANT SHRUB MASSINGS FOUND ON SITE SHALL BE PROTECTED AND SAVED UNLESS NOTED TO BE REMOVED OR ARE LOCATED IN AN AREA TO BE GRADED. QUESTIONS REGARDING EXISTING PLANT MATERIAL SHALL BE BROUGHT TO THE ATTENTION OF THE LANDSCAPE ARCHITECT PRIOR TO REMOVAL.
- 12. EXISTING OR FOUND BOULDERS ON SITE SHALL BE PROTECTED AND STOCKPILED FOR FUTURE USE.
- 13. EXISTING TREES TO REMAIN, UPON DIRECTION OF LANDSCAPE ARCHITECT, SHALL BE FERTILIZED AND PRUNED TO REMOVE DEAD WOOD, DAMAGED AND RUBBING BRANCHES.
- 14. CONTRACTOR SHALL PREPARE AND SUBMIT A WRITTEN REQUEST FOR THE SUBSTANTIAL COMPLETION INSPECTION OF LANDSCAPE AND SITE IMPROVEMENTS PRIOR TO SUBMITTING FINAL PAY REQUEST.
- 15. CONTRACTOR SHALL PREPARE AND SUBMIT REPRODUCIBLE
 AS-BUILT DRAWING(S) OF LANDSCAPE INSTALLATION, IRRIGATION
 AND SITE IMPROVEMENTS UPON COMPLETION OF CONSTRUCTION
 INSTALLATION AND PRIOR TO SUBSTANTIAL COMPLETION.
- 16. SYMBOLS ON PLAN DRAWING TAKE PRECEDENCE OVER SCHEDULES IF DISCREPANCIES IN QUANTITIES EXIST. SPECIFICATIONS AND DETAILS TAKE PRECEDENCE OVER NOTES.

SOIL TESTING

- CONTRACTOR SHALL OBTAIN A SOIL SAMPLE(S) FROM PROJECT SITE AND/OR SALVAGED TOPSOIL STOCKPILE AND SUBMIT TO INDEPENDENT TESTING AGENCY. ANALYSIS AND RECOMMENDATIONS FOR (INCLUDING BUT NOT LIMITED TO) MACRONUTRIENTS, MICRONUTRIENTS, COMPOSITION AND SOLUBLE SALTS SHALL BE PROVIDED.
- 2. CONTRACTOR SHALL PROVIDE ANALYSIS RESULTS AND RECOMMENDATIONS TO THE LANDSCAPE ARCHITECT FOR REVIEW AND APPROVAL PRIOR TO SOIL AMENDMENT AND PRIOR TO PLANTING.

GRADING

- 1. ROUGH GRADING AND FINISHED GRADING TO BE DONE BY OTHERS EXCEPT WHERE NOTED.
- 2. GRADING LIMITS ARE DEFINED AS THE JUNCTURE OF PROPOSED GRADE WITH EXISTING GRADE UNLESS NOTED OTHERWISE.
- 3. GRADING LIMITS AND LIMITS OF WORK SHOWN ON PLAN ARE ONLY APPROXIMATE AND MAY BE ADJUSTED IN FIELD BY LANDSCAPE ARCHITECT. WORK OUTSIDE OF THESE LIMITS WILL BE DONE AT LANDSCAPE CONTRACTORS EXPENSE UNLESS DIRECTED BY LANDSCAPE ARCHITECT OR OWNER IN WRITING.
- 4. FILL/CUT AS NECESSARY TO PROVIDE A 1% MINIMUM GRADE AWAY FROM BUILDINGS WITHIN LIMITS OF CONSTRUCTION.

- 5. SALVAGE TOPSOIL FROM THE EARTHWORK AREAS AS APPROPRIATE OR AS INDICATED ON PLANS AND STOCKPILE FOR REUSE.
- 6. MAINTAIN A UNIFORM GRADE BETWEEN CONTOURS IN AREAS TO BE GRADED UNLESS NOTED OTHERWISE.
- 7. ELEVATIONS, IF SHOWN ARE FINISHED ELEVATIONS. SPOT ELEVATIONS TAKE PRECEDENCE OVER CONTOURS.
- 8. ADD EROSION CONTROL MEASURES IF GRADES GREATER THAN 3:1 OR IF CONDITIONS WARRANT. REFER TO MNDOT SPECIFICATIONS FOR EROSION CONTROL.
- CONTRACTOR SHALL CONTACT PUBLIC UTILITIES FOR LOCATION OF UNDERGROUND WIRES, CABLES, CONDUITS, PIPES, MANHOLES, VALVES OR OTHER BURIED STRUCTURES BEFORE DIGGING. LANDSCAPE CONTRACTOR SHALL REPAIR OR REPLACE THE ABOVE IF DAMAGED DURING CONSTRUCTION AT NO ADDITIONAL COST TO THE OWNER.
- 10. CONTRACTOR SHALL PROVIDE PROPER EROSION CONTROL MEASURES AS REQUIRED TO ENSURE THAT EROSION IS KEPT TO AN ABSOLUTE MINIMUM.
- 11. PROVIDE TEMPORARY COVERING FOR CATCH BASINS AND MAN HOLES UNTIL FINISHED GRADING IS COMPLETE.
- 12. CONTRACTOR SHALL CONSTRUCT DRAINAGE BASINS AS NEEDED.
- 13. PERIMETER SILT FENCE AND ROCK CONSTRUCTION ENTRANCES SHALL BE INSTALLED PRIOR TO CONSTRUCTION. REFER TO STATE SPECIFICATIONS FOR AGGREGATE BASE AND SILT FENCE.
- 14. CONTRACTOR SHALL INSTALL CATCH BASIN EROSION CONTROL MEASURES PER LOCAL POLLUTION CONTROL AGENCY AND SPECIFICATIONS.
- 15. WITHIN TWO WEEKS OF FINISHED SITE GRADING, DISTURBED AREAS SHALL BE STABILIZED WITH SEED, SOD, MULCH OR ROCK BASE.
- 16. CONTRACTOR SHALL MAINTAIN EROSION CONTROL MEASURES, INCLUDING THE REMOVAL OF ACCUMULATED SILT IN FRONT OF SILT FENCES AND EXCESS SEDIMENT IN PROPOSED CATCH BASINS, FOR THE DURATION OF CONSTRUCTION.
- 17. CONTRACTOR SHALL REMOVE EROSION CONTROL MEASURES AFTER VEGETATION IS ESTABLISHED AND DISPOSE OF OFF SITE.
- 18. CONTRACTOR SHALL ENSURE THAT SOIL CONDITIONS AND COMPACTION ARE ADEQUATE TO ALLOW FOR PROPER DRAINAGE AROUND THE CONSTRUCTION SITE. UNDESIRABLE CONDITIONS SHALL BE BROUGHT TO THE ATTENTION OF THE LANDSCAPE ARCHITECT PRIOR TO BEGINNING OF WORK. IT SHALL BE THE LANDSCAPE CONTRACTOR'S RESPONSIBILITY TO ENSURE PROPER SURFACE AND SUBSURFACE DRAINAGE IN PLANTING AREAS.

PLANTING

- SPRING PLANT MATERIAL INSTALLATION IS FROM APRIL 15 TO JUNE 15,
- 2. FALL CONIFEROUS PLANTING IS ACCEPTABLE FROM AUGUST 21 TO SEPTEMBER 30.
- 3. FALL DECIDUOUS PLANTING IS ACCEPTABLE FROM AUGUST 15 UNTIL NOVEMBER 15.
- 4. ADJUSTMENTS TO PLANTING DATES MUST BE APPROVED IN WRITING BY THE LANDSCAPE ARCHITECT.
 5. STAKE PROPOSED PLANTING LOCATIONS PER PLAN FOR REVIEW AND APPROVAL BY LANDSCAPE ARCHITECT PRIOR TO INSTALL.
- 6. PLANT MATERIAL SHALL COMPLY WITH THE CURRENT EDITION OF THE AMERICAN STANDARD FOR NURSERY STOCK, ANSI Z60.1. UNLESS NOTED OTHERWISE, DECIDUOUS SHRUBS SHALL HAVE AT LEAST 5 CANES AT THE SPECIFIED HEIGHT. ORNAMENTAL TREES SHALL HAVE NO 'V' CROTCHES AND SHALL BEGIN BRANCHING NO LOWER THAN 3' FEET ABOVE THE ROOT BALL. STREET AND BOULEVARD TREES SHALL BEGIN BRANCHING NO LOWER THAN 6' ABOVE PAVED SURFACE.
- 7. INSTALL PLANT MATERIAL AFTER FINAL GRADING AND CONSTRUCTION HAS BEEN COMPLETED IN THE IMMEDIATE AREA.
- 8. INSTALL PLANT MATERIALS PER PLANTING DETAILS.
- SUBSTITUTION REQUESTS FOR PLANT MATERIAL TYPE & SIZE SHALL BE SUBMITTED TO THE LANDSCAPE ARCHITECT FOR CONSIDERATION PRIOR TO BIDDING. SUBSTITUTIONS AFTER BIDDING MUST BE APPROVED BY LANDSCAPE ARCHITECT AND ARE SUBJECT TO CONTRACT ADJUSTMENTS.
- 10. ADJUSTMENTS IN LOCATION OF PROPOSED PLANT MATERIALS MAY BE NEEDED IN FIELD, LANDSCAPE ARCHITECT MUST BE NOTIFIED PRIOR TO ADJUSTMENT OF PLANTS.
- 11. FERTILIZE PLANT MATERIALS IN ACCORDANCE WITH SOIL TEST RECOMMENDATIONS.
- 12. INSTALL 18" DEPTH OF PLANTING SOIL IN AREAS RECEIVING GROUND COVER, PERENNIALS, AND ANNUALS.
- 13. TREE WRAPPING MATERIAL SHALL BE PAPER APPLIED FROM TRUNK FLARE TO FIRST BRANCH, WRAP SMOOTH-BARKED DECIDUOUS TREES PLANTED IN THE FALL PRIOR TO DECEMBER 1 AND REMOVE WRAPPING AFTER MAY 1.
- 14. APPLY PRE-EMERGENT HERBICIDE (PREEN OR APPROVED EQUAL) IN ANNUAL, PERENNIAL, AND SHRUB BEDS FOLLOWED BY SHREDDED HARDWOOD MULCH. REFER TO SPECIFICATIONS FOR ADDITIONAL INFORMATION REGARDING USE OF HERBICIDES.

MULCHING

- INSTALL 4" DEEP FINELY SHREDDED HARDWOOD MULCH RINGS AT CONIFEROUS & DECIDUOUS TREES WITH NO MULCH IN DIRECT CONTACT WITH TREE TRUNK.
- 2. INSTALL 3" DEEP FINELY SHREDDED HARDWOOD MULCH RINGS AT SHRUB PLANTING AREAS WITH NO MULCH IN DIRECT CONTACT WITH SHRUB STEMS.

 INSTALL 3" DEEP FINELY SHREDDED MULCH IN PERENNIAL PLANTING BEDS. REMOVE ALL MULCH FROM STEMS OF PERENNIALS; PLANT STEMS SHOULD NOT BE IN DIRECT CONTACT WITH MULCH.

NATERING

- PLANTED MATERIALS SHALL BE WATERED BY TEMPORARY MEANS UNTIL PLANTS ARE ESTABLISHED.
- TEMPORARY WATERING MEANS, METHODS, AND SCHEDULING SHALL BE THE CONTRACTOR'S RESPONSIBILITY. REMOVE TEMPORARY WATERING EQUIPMENT UPON PLANT ESTABLISHMENT.

WARRANTY

 WARRANTY NEW PLANT MATERIAL THROUGH ONE CALENDAR YEAR FROM THE DATE OF SUBSTANTIAL COMPLETION. NO PARTIAL ACCEPTANCE WILL BE CONSIDERED.

TURF NOTES

- SEED AREAS DISTURBED DUE TO GRADING UNLESS NOTED
 OTHERWISE
- WHERE SEEDED AREAS ABUTS PAVED SURFACES, FINISHED GRADE SHALL BE HELD 1" BELOW SURFACE ELEVATION OF TRAIL, SI AB CHRB FTC
- UNLESS NOTED OTHERWISE, THE APPROPRIATE DATES FOR SEED PLACEMENT IS FROM THE TIME GROUND HAS THAWED TO JUNE 15
- FALL SEEDING IS ACCEPTABLE FROM AUGUST 15 TO SEPTEMBER
 15. ADJUSTMENTS TO SEED PLANTING DATES MUST BE
 APPROVED IN WRITING BY THE LANDSCAPE ARCHITECT.

IRRIGATION NOTES

- 1. CONTRACTOR SHALL BE RESPONSIBLE FOR PROVIDING AN IRRIGATION LAYOUT PLAN AND SPECIFICATION THAT MEETS THE REQUIREMENTS OF THE PROVIDED PERFORMANCE SPECIFICATION AS PART OF THE SCOPE OF WORK. SUBMIT LAYOUT PLAN AND SPECIFICATIONS FOR APPROVAL BY THE LANDSCAPE ARCHITECT PRIOR TO ORDER AND/OR CONSTRUCTION. IT SHALL BE THE CONTRACTOR'S RESPONSIBILITY TO ENSURE THAT SODDED/SEEDED AND PLANTED AREAS ARE IRRIGATED PROPERLY, INCLUDING THOSE AREAS DIRECTLY AROUND AND ABUTTING BUILDING FOUNDATION.
- CONTRACTOR SHALL FIELD VERIFY WATER SUPPLY, VOLUME, PRESSURE AND LOCATION FOR SYSTEM TAP PRIOR TO SYSTEM DESIGN.
- CONTRACTOR SHALL FIELD VERIFY AND INSPECT EXISTING IRRIGATION SYSTEM LAYOUT, EQUIPMENT, CONDITION AND OPERABILITY PRIOR TO SYSTEM DESIGN.
- 4. CONTRACTOR SHALL CONFIRM COMPLETE LIMITS OF IRRIGATION WITH LANDSCAPE ARCHITECT PRIOR TO SUPPLYING SHOP DRAWINGS.
- 5. CONTRACTOR SHALL CONTACT LANDSCAPE ARCHITECT FOR INSPECTION AND APPROVAL OF AREAS RECEIVING DRIP IRRIGATION PRIOR TO INSTALLATION OF MULCH.
- 6. CONTRACTOR SHALL PROVIDE THE OWNER AND LANDSCAPE ARCHITECT WITH AS-BUILT DRAWINGS, DETAILED SYSTEM OPERATION INSTRUCTIONS AND AN IRRIGATION SCHEDULE APPROPRIATE TO THE PROJECT SITE CONDITIONS AND PLANTED MATERIAL GROWTH REQUIREMENTS.



CITY OF SAINT PETER 227 South Front Street Saint Peter, MN 56082 p: 507.934.4840

DF/ DAMON FARBER LANDSCAPE ARCHITECTS

310 South 4th Avenue, Suite 7050 Minneapolis, MN 55415 p: 612,332,7522



BOLTON & MENK 1960 PREMIER DRIVE MANKATO, MN 56001-5900 p: 507.625.4171

NELSOM-RUDIE NELSOM-RUDIE & ASSOCIATES 9100 49TH AVE NORTH MINNEAPOLIS, MN 55428 612.669, 4385

100% CONSTRUCTION DRAWINGS

GORMAN PARK
ST. PETER, MINNESOTA

I hereby certify that this document was prepared by me or under my direct supervision and that I am a duly licensed Landscape Architect under the laws of the State of Minnesota.

Name Thomas Whitlock
Registration# 26292

100% CD SET 12/24/2024

DF / Project # 22-15(

Scale PER SHEET

Drawn/Checked AG / RP / JR / JW

REVISION --

LANDSCAPE NOTES

G002

EXISTING TOPOGRAPHIC SYMBOLS

XIST	ING TOPOGRAPHIC SYMBOLS		
	ACCESS GRATE	6	REGULATION STATION GAS
AC	AIR CONDITION UNIT	<u>k</u> -	SATELLITE DISH
D	ANTENNA		SIGN TRAFFIC
5	AUTO SPRINKLER CONNECTION	⊞	SIGNAL CONTROL CABINET
U	BARRICADE PERMANENT	*	SOIL BORING
0	BASKETBALL POST	Es .	SIREN
≌	BENCH	(TELEPHONE BOOTH
В-	BIRD FEEDER		TILE INLET
B	BOLLARD	©TILE	TILE OUTLET
٥	BUSH	©	TILE RISER
2	CATCH BASIN RECTANGULAR CASTING		TRANSFORMER-ELECTRIC
\mathbb{D}	CATCH BASIN CIRCULAR CASTING	*	TREE-CONIFEROUS
8	CURB STOP	*	TREE-DEAD
<u></u>	CLEAN OUT	\odot	TREE-DECIDUOUS
©CLVT	CULVERT END	P	TREE STUMP
8	DRINKING FOUNTAIN	•	TRAFFIC ARM BARRIER
0	DOWN SPOUT	(E)	TRAFFIC SIGNAL
EV	ELECTRIC CAR CHARGE STATION	TRASH	TRASH CAN
Ð	FILL PIPE	U	UTILITY MARKER
φ–	FIRE HYDRANT	\bowtie	VALVE
~	FLAG POLE	\otimes	VALVE POST INDICATOR
\triangleright	FLARED END / APRON		VALVE VAULT
	FUEL PUMP	V	VAULT
₽	GRILL	(VENT PIPE
\leftarrow	GUY WIRE ANCHOR	⊗ws	WATER SPIGOT
Н	HANDHOLE		WELL
Ě	HANDICAP SPACE	Δ	WETLAND DELINEATED MARKER
Ħ	IRRIGATION SPRINKLER HEAD	714	WETLAND
×	IRRIGATION VALVE BOX	WW	WET WELL
CP	LIFT STATION CONTROL PANEL	ூ	YARD HYDRANT
D	LIFT STATION		
¢-	LIGHT POLE	PROPOSE	D TOPOGRAPHIC SYMBOLS
21	MAILBOX	•	CLEANOUT
0	MANHOLE-COMMUNICATION		MANHOLE
Ē	MANHOLE-ELECTRIC		LIFT STATION
6	MANHOLE-GAS	0	STORM SEWER CIRCULAR CASTING
H	MANHOLE-HEAT	•	STORM SEWER RECTANGULAR CASTING
W	MANHOLE-RECLAIMED WATER	_	STORM SEWER FLARED END / APRON
3)	MANHOLE-SANITARY SEWER		STORM SEWER OUTLET STRUCTURE
D	MANHOLE-STORM SEWER	_	STORM SEWER OUTER STRUCTURE

- CASTING
- JLAR CASTING
- ND / APRON
- RUCTURE

STORM SEWER OVERFLOW STRUCTURE

- - CURB BOX
 - FIRE HYDRANT
 - WATER VALVE
 - WATER REDUCER
 - WATER BEND
 - 凸 WATER TEE
 - ⊕ WATER CROSS
 - WATER SLEEVE

WATER CAP / PLUG

DRAINAGE FLOW


 \oplus

- RIP RAP
- Þ٢ TRAFFIC SIGNS

SURVEY SYMBOLS

- BENCHMARK LOCATION
- CAST IRON MONUMENT
- CONTROL POINT STONE MONUMENT
- MONUMENT FOUND

EXISTING TOPOGRAPHIC LINES

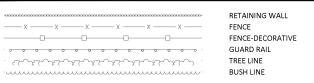

SURVEY LINES


	CONTROLLED ACCESS
	BOUNDARY
	CENTERLINE
	EXISTING EASEMENT LINE
	PROPOSED EASEMENT LIN
	EXISTING LOT LINE
	PROPOSED LOT LINE
	EXISTING RIGHT-OF-WAY
	PROPOSED RIGHT-OF-WA
	SETBACK LINE
	SECTION LINE
··	QUARTER LINE
	SIXTEENTH LINE
	TEMPORARY EASEMENT

ACCESS SEMENT LINE ASEMENT LINE T LINE OT LINE HT-OF-WAY IGHT-OF-WAY INE

EXISTING UTILITY LINES


	FORCEMAIN
	SANITARY SEWER
$\rightarrow \rightarrow $	SANITARY SERVICE
	STORM SEWER
<i>→> →> →> →> →> →> →> →></i>	STORM SEWER DRAIN TILE
	WATERMAIN
-1111111111	WATER SERVICE
	RECLAIMED WATER

PROPOSED UTILITY LINES

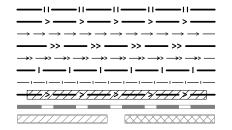

FORCEMAIN SANITARY SEWER SANITARY SERVICE STORM SEWER STORM SEWER DRAIN TILE WATERMAIN WATER SERVICE PIPE CASING TRENCHLESS PIPE (PLAN VIEW) TRENCHLESS PIPE (PROFILE VIEW)

GRADING INFORMATION

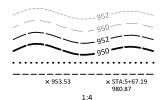

EXISTING CONTOUR MINOR EXISTING CONTOUR MAJOR PROPOSED CONTOUR MINOR PROPOSED CONTOUR MAJOR PROPOSED GRADING LIMITS / SLOPE LIMITS PROJECT LIMITS PROPOSED SPOT ELEVATION RISE:RUN (SLOPE)

HATCH PATTERNS





EXISTING PRIVATE UTILITY LINES

EXISTING UTILITY INFORMATION SHOWN ON THIS PLAN HAS BEEN PROVIDED BY THE UTILITY OWNER. THE CONTRACTOR SHALL FIELD VERIFY EXACT LOCATIONS PRIOR TO COMMENCING CONSTRUCTION AS REQUIRED BY STATE LAW. NOTIFY GOPHER STATE ONE CALL, 1-800-252-1166 OR

THE SUBSURFACE UTILITY INFORMATION IN THIS PLAN IS UTILITY QUALITY LEVEL D UNLESS OTHERWISE NOTED. THIS UTILITY LEVEL WAS DETERMINED ACCORDING TO THE GUIDELINES OF CI/ASCE 38-22, ENTITLED "STANDARD GUIDELINE FOR INVESTIGATING AND DOCUMENTING **EXISTING UTILITIES"**

F	— F —	— F ——	- F	UNDERGROUND FIBER OPTIC
—— Е—	— Е —	— Е ——	— Е ———	UNDERGROUND ELECTRIC
	G	G	— G ———	UNDERGROUND GAS
c_	c	c	_ c	UNDERGROUND COMMUNICATION
—— OE ——	— OE —	OE	OE	OVERHEAD ELECTRIC
— ос —	— ос —	oc	oc	OVERHEAD COMMUNICATION
ou	— ou —	ou	ou	OVERHEAD UTILITY

UTILITIES IDENTIFIED WITH A QUALITY LEVEL:

LINE TYPES FOLLOW THE FORMAT: UTILITY TYPE - QUALITY LEVEL UNDERGROUND GAS, QUALITY LEVEL A UTILITY QUALITY LEVEL (A,B,C,D) DEFINITIONS CAN BE FOUND IN CI/ASCE 38-22.

UTILITY QUALITY LEVELS:

QUALITY LEVEL D: PROVIDES THE MOST BASIC LEVEL OF INFORMATION. IT INVOLVES COLLECTING DATA FROM EXISTING UTILITY RECORDS. RECORDS MAY INCLUDE AS-BUILT DRAWINGS, DISTRIBUTION AND SERVICES MAPS, EXISTING GEOGRAPHIC INFORMATION SYSTEM DATABASES,

QUALITY LEVEL C: INVOLVES SURVEYING VISIBLE SUBSURFACE UTILITY STRUCTURES SUCH AS MANHOLES, HAND-HOLES, UTILITY VALVES AND METERS, FIRE HYDRANTS, PEDESTALS AND UTILITY MARKERS, AND THEN CORRELATING THE INFORMATION WITH EXISTING UTILITY RECORDS TO CREATE COMPOSITE DRAWINGS. INCLUDES QUALITY LEVEL D ACTIVITIES.

QUALITY LEVEL B: INVOLVES DESIGNATING THE HORIZONTAL POSITION OF SUBSURFACE UTILITIES THROUGH SURFACE DETECTION METHODS AND COLLECTING THE INFORMATION THROUGH A SURVEY METHOD. INCLUDES QUALITY LEVEL C AND D TASKS.

QUALITY LEVEL A: PROVIDES THE HIGHEST LEVEL OF ACCURACY. IT INVOLVES LOCATING OR POTHOLING UTILITIES AS WELL AS ACTIVITIES IN QUALITY LEVELS B, C, AND D. THE LOCATED FACILITY INFORMATION IS SURVEYED AND MAPPED AND THE DATA PROVIDES PRECISE PLAN AND PROFILE INFORMATION

GRAVEL

GRAV

ABBREVIATIONS

ALGEBRAIC DIFFERENCE

GRANULAR

ADJ	ADJUST	GU	GUTTER	RT	RIGHT
ALT	ALTERNATE	GV	GATE VALVE	SAN	SANITARY SEWER
B-B	BACK TO BACK	HDPE	HIGH DENSITY POLYETHYLENE	SCH	SCHEDULE
ЗIT	BITUMINOUS	нн	HANDHOLE	SERV	SERVICE
BLDG	BUILDING	HP	HIGH POINT	SHLD	SHOULDER
ВМР	BEST MANAGEMENT PRACTICE	HWL	HIGH WATER LEVEL	STA	STATION
3R	BEGIN RADIUS	HYD	HYDRANT	STD	STANDARD
ВV	BUTTERFLY VALVE	1	INVERT	STM	STORM SEWER
CB	CATCH BASIN	K	CURVE COEFFICIENT	TC	TOP OF CURB
C&G	CURB AND GUTTER	L	LENGTH	TE	TEMPORARY EASEMENT
CIP	CAST IRON PIPE	LO	LOWEST OPENING	TEMP	TEMPORARY
CIPP	CURED-IN-PLACE PIPE	LP	LOW POINT	TNH	TOP NUT HYDRANT
CL	CENTER LINE	LT	LEFT	TP	TOP OF PIPE
CL.	CLASS	MAX	MAXIMUM	TYP	TYPICAL
CLVT	CULVERT	MH	MANHOLE	VCP	VITRIFIED CLAY PIPE
CMP	CORRUGATED METAL PIPE	MIN	MINIMUM	VERT	VERTICAL
C.O.	CHANGE ORDER	MR	MID RADIUS	VPC	VERTICAL POINT OF CURVE
COMM	COMMUNICATION	NIC	NOT IN CONTRACT	VPI	VERTICAL POINT OF INTERSECTION
CON	CONCRETE	NMC	NON-METALLIC CONDUIT	VPT	VERTICAL POINT OF TANGENT
CSP	CORRUGATED STEEL PIPE	NTS	NOT TO SCALE	WM	WATERMAIN
DIA	DIAMETER	NWL	NORMAL WATER LEVEL		
DIP	DUCTILE IRON PIPE	OHW	ORDINARY HIGH WATER LEVEL		
OWY	DRIVEWAY	PC	POINT OF CURVE	AC	ACRES
Ε	EXTERNAL CURVE DISTANCE	PCC	POINT OF COMPOUND CURVE	CF	CUBIC FEET
ELEC	ELECTRIC	PE	PERMANENT EASEMENT	CV	COMPACTED VOLUME
ELEV	ELEVATION	PED	PEDESTRIAN, PEDESTAL	CY	CUBIC YARD
EOF	EMERGENCY OVERFLOW	PERF	PERFORATED PIPE	EA	EACH
ΕR	END RADIUS	PERM	PERMANENT	EV	EXCAVATED VOLUME
ESMT	EASEMENT	PI	POINT OF INTERSECTION	LB	POUND
ΞX	EXISTING	PL	PROPERTY LINE	LF	LINEAR FEET
ES	FLARED END SECTION	PRC	POINT OF REVERSE CURVE	LS	LUMP SUM
F-F	FACE TO FACE	PT	POINT OF TANGENT	LV	LOOSE VOLUME
FF	FINISHED FLOOR	PVC	POLYVINYL CHLORIDE PIPE	SF	SQUARE FEET
-&I	FURNISH AND INSTALL	PVMT	PAVEMENT	SV	STOCKPILE VOLUME
M	FORCEMAIN	R	RADIUS	SY	SQUARE YARD
=O	FIBER OPTIC	R/W	RIGHT-OF-WAY		
O.	FIELD ORDER	RCP	REINFORCED CONCRETE PIPE		

RETAINING



CITY OF SAINT PETER 227 South Front Street Saint Peter, MN 56082 p: 507.934.4840

DAMON FARBER LANDSCAPE ARCHITECTS

310 South 4th Avenue, Suite 7050 Minneapolis, MN 55415 p: 612.332.7522



BOLTON & MENK MANKATO, MN 56001-5900 p: 507.625.4171



NELSON-RUDIE & ASSOCIATES 9100 49TH AVE NORTH MINNEAPOLIS, MN 55428 612.669.4385

CONSTRUCTION

RIGID STEEL CONDUIT

RSC

GORMAN PARK PHASE 1

ST. PETER, MINNESOTA

100% CD SET 12/24/2024 0M1.133927 BMI Project # DF/ Project # 22-150 PER SHEET Scale JAD/JPS Designed

LEGEND

REVISION

MANHOLE-UTILITY

MANHOLE-WATER

PARKING METER

PAVEMENT MARKING

PEDESTAL-ELECTRIC

POLE-UTILITY


DRIVE-THRU MICROPHONE

PEDESTAL-COMMUNICATION

PEDESTRIAN PUSH BUTTON

RAILROAD SIGNAL POLE

METER

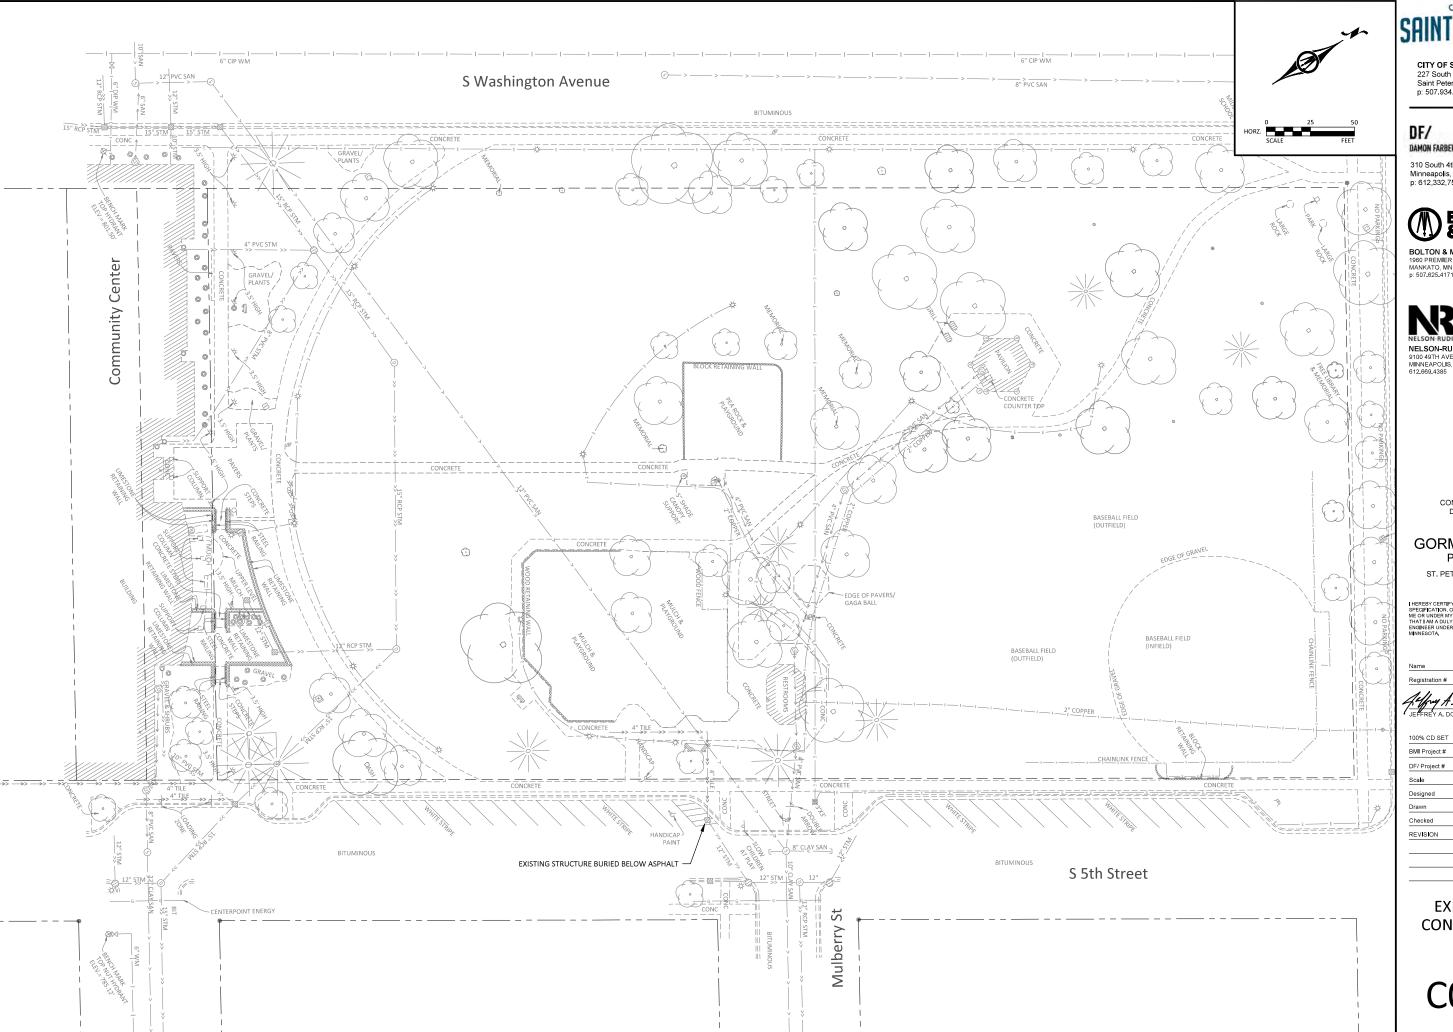



DAMON FARBER LANDSCAPE ARCHITECTS

310 South 4th Avenue, Suite 7050 Minneapolis, MN 55415 p: 612,332,7522



BOLTON & MENK 1960 PREMIER DRIVE MANKATO, MN 56001-5900 p: 507.625.4171

NELSON-RUDIE & ASSOCIATES 9100 49TH AVE NORTH MINNEAPOLIS, MN 55428 612.669.4385

100% CONSTRUCTION DRAWINGS


GORMAN PARK PHASE 1

ST. PETER, MINNESOTA

12/24/2024

0M1.133927 22-150 PER SHEET JAD/JPS

> **EXISTING CONDITIONS**

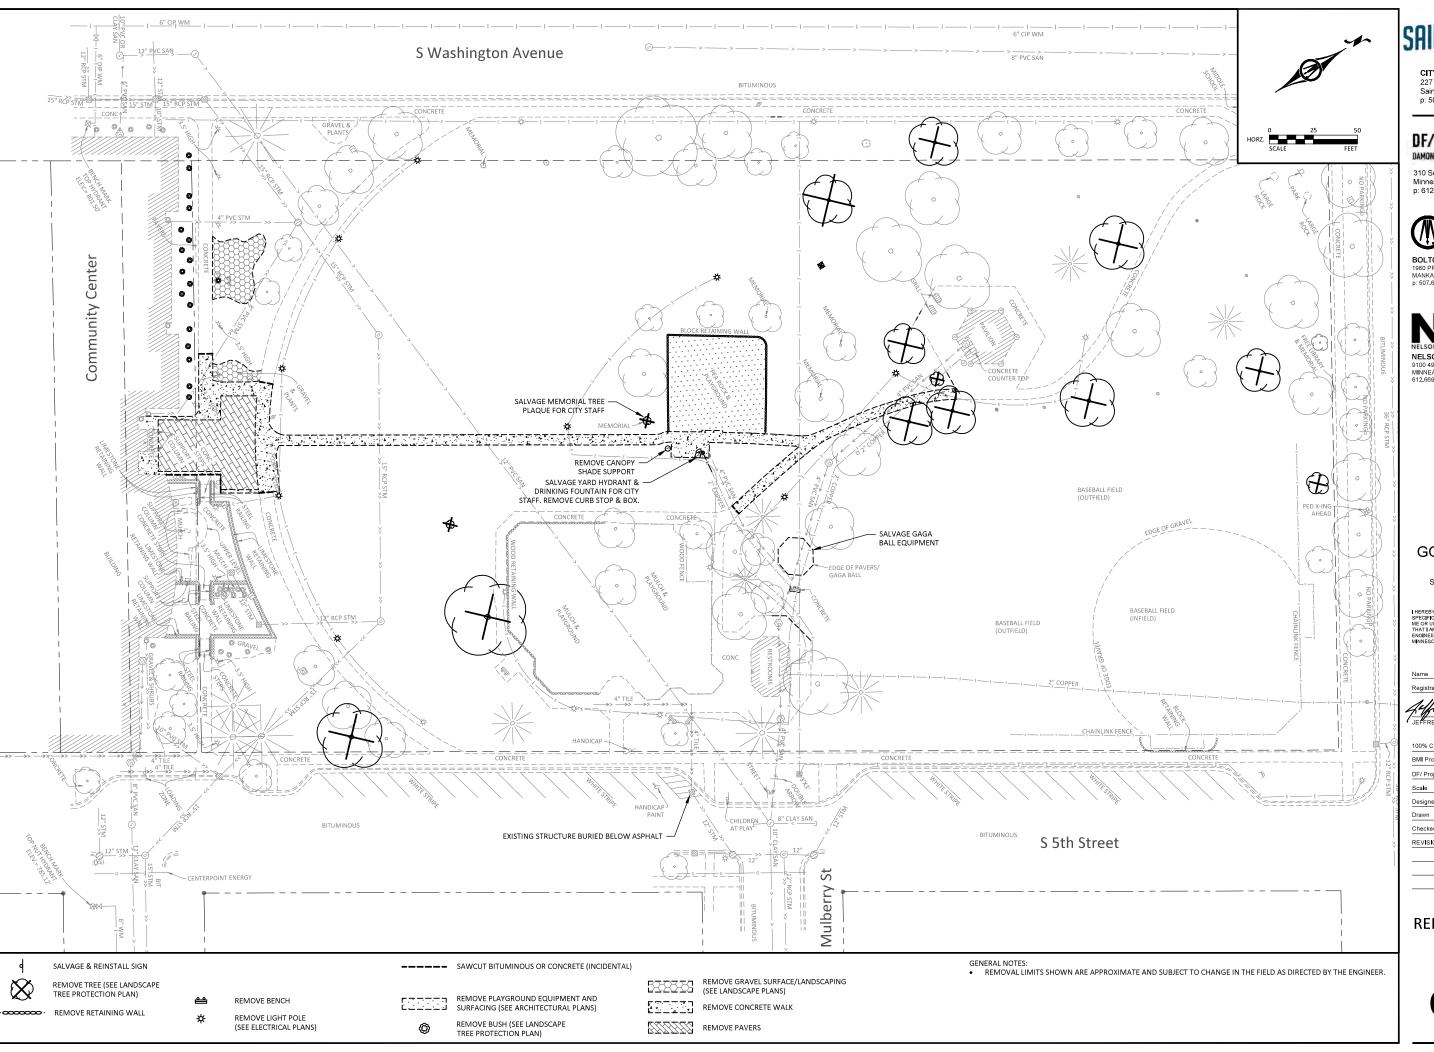



DAMON FARBER LANDSCAPE ARCHITECTS

310 South 4th Avenue, Suite 7050 Minneapolis, MN 55415 p: 612,332,7522



BOLTON & MENK 1960 PREMIER DRIVE MANKATO, MN 56001-5900 p: 507.625.4171

EL SON-RUDIE

NELSON-RUDIE & ASSOCIATES 9100 49TH AVE NORTH MINNEAPOLIS, MN 55428 612.669.4385

> 100% CONSTRUCTION DRAWINGS

GORMAN PARK PHASE 1

ST. PETER, MINNESOTA

I HEREBY CERTIFY THAT THIS PLAN, SPECIFICATION, OR REPORT WAS PREPARED BY ME OR UNDER MY DIRECT SUPERVISION AND THAT I AM A DULY LICENSED PROFESSIONAL ENGINEER UNDER THE LAWS OF THE STATE OF MINNESOTA

Name Jeffrey A. Domras

Registration # 26464

 100% CD SET
 12/24/2024

 BMI Project #
 0M1.133927

 DF/ Project #
 22-150

 Scale
 PER SHEET


 Designed
 JAD/JPS

 Drawn
 JPS

 Checked
 JAD

 REVISION


REMOVAL PLAN

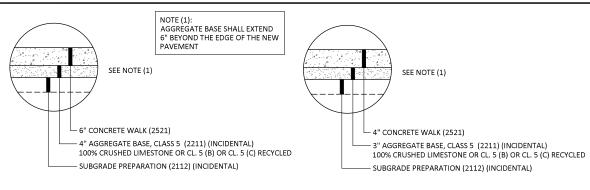


6" CONCRETE WALK

NOT TO SCALE

4" CONCRETE WALK NOT TO SCALE

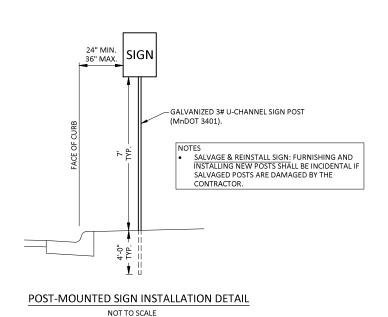

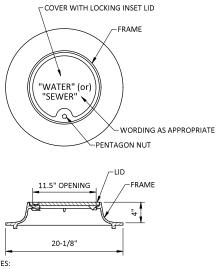

- NOTES:
 1. FURNISH AND INSTALL ON CURB STOPS AND CLEANOUTS THAT ARE WITHIN CONCRETE OR BITUMINOUS SURFACES.
 - CASTING ASSEMBLY TO BE FORD METER BOX MODEL A32 OR APPROVED EQUAL.

CASTING ASSEMBLY SPECIAL

NOT TO SCALE



CITY OF SAINT PETER 227 South Front Street Saint Peter, MN 56082 p: 507.934.4840

DAMON FARBER LANDSCAPE ARCHITECTS

310 South 4th Avenue, Suite 7050 Minneapolis, MN 55415 p: 612,332,7522



BOLTON & MENK 1960 PREMIER DRIVE MANKATO, MN 56001-5900 p: 507.625.4171

NELSON-RUDIE & ASSOCIATES 9100 49TH AVE NORTH MINNEAPOLIS, MN 55428 612.669.4385

100% CONSTRUCTION

GORMAN PARK PHASE 1

ST. PETER, MINNESOTA

Registration #

100% CD SET 12/24/2024 0M1.133927 BMI Project # 22-150 DF/ Project # PER SHEET Scale Designed JAD/JPS REVISION


TYPICAL SECTIONS & DETAILS

CIVIL SURFACING DETAILS

NOTE: WHERE NO EXISTING WATER SERVICE IS INPLACE, EXTEND PAST PROPERTY LINE 12' AND CRIMP END OF COPPER.


CORPORATION STOPS, CURB STOPS & RELATED FITTINGS SHALL BE CAST BRASS WITH COMPRESSION FITTINGS EXTENSION ROD SHALL EXTEND WITHIN 12" OF GROUND SURFACE

NO COUPLINGS ALLOWED BETWEEN WATERMAIN AND CURB STOP AND FROM THE CURB STOP TO THE STUBBED CRIMPED END OF THE COPPER (UNLESS DIRECTED OTHERWISE BY THE CITY).

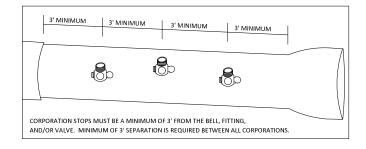


** NOTE:


AN A-32 FORD WATER COVER IS REQUIRED
WHEN THE CURB STOP BOX IS LOCATED IN A
CONCRETE OR BITUMINOUS SURFACE.

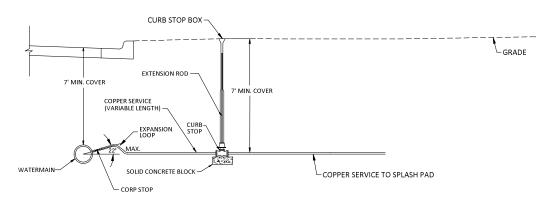

WATER SERVICE DETAIL

NOT TO SCALE

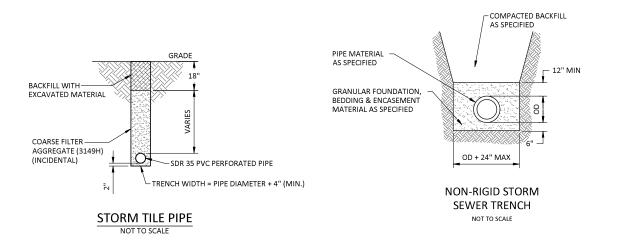

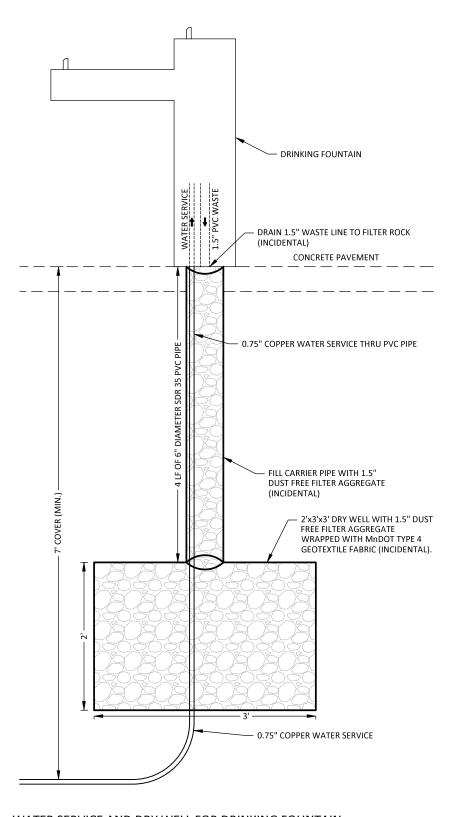

WATER SERVICE AND DRY WELL FOR DRINKING FOUNTAIN

NOT TO SCALE



CITY OF SAINT PETER 227 South Front Street Saint Peter, MN 56082 p: 507.934.4840

DF/

DAMON FARBER LANDSCAPE ARCHITECTS

310 South 4th Avenue, Suite 7050 Minneapolis, MN 55415 p: 612,332,7522



BOLTON & MENK 1960 PREMIER DRIVE MANKATO, MN 56001-5900 p: 507.625.4171



NELSON-RUDIE & ASSOCIATES 9100 49Th AVE NORTH MINNEAPOLIS, MN 55428 612.669.4385

> 100% CONSTRUCTION

GORMAN PARK PHASE 1

ST. PETER, MINNESOTA

I HEREBY CERTIFY THAT THIS PLAN, SPECIFICATION, OR REPORT WAS PREPARED ME OR UNDER MY DIRECT SUPERVISION AND THAT I AM A DULY LICENSED PROFESSIONAL ENGINEER UNDER THE LAWS OF THE STATE C MINNESOTA.


 Designed
 JADI/JPS


 Drawn
 JPS


 Checked
 JAD


 REVISION

TYPICAL SECTIONS & DETAILS
CIVIL UTILITY DETAILS

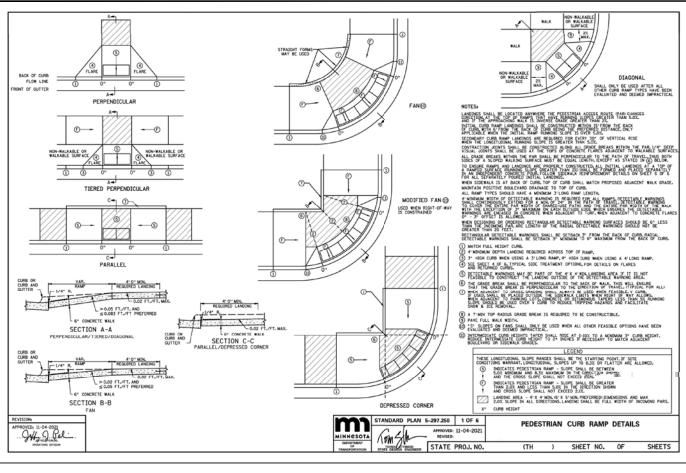

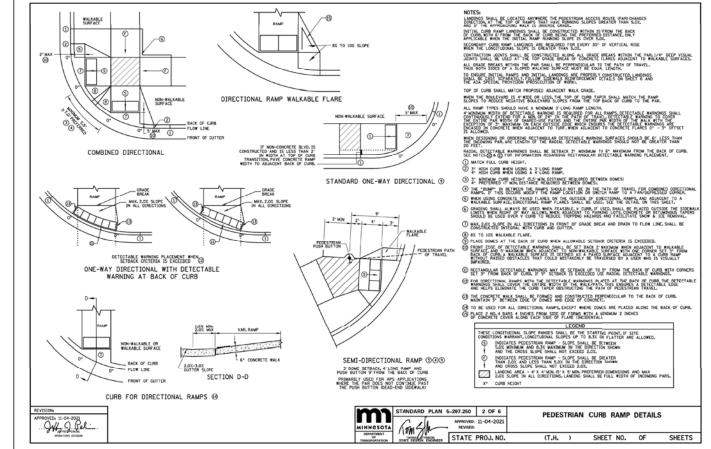

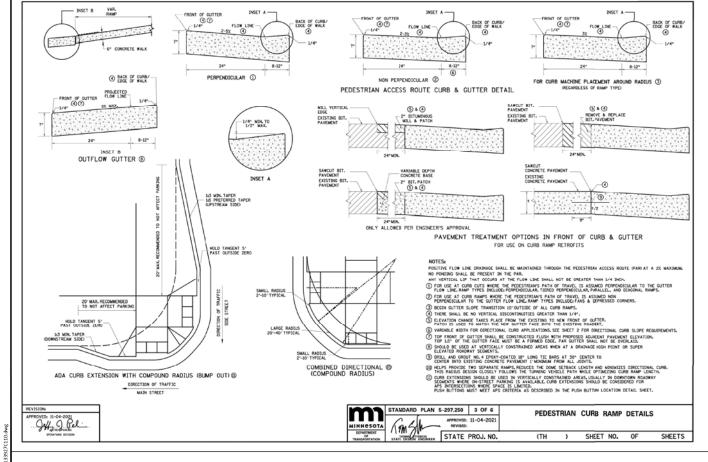

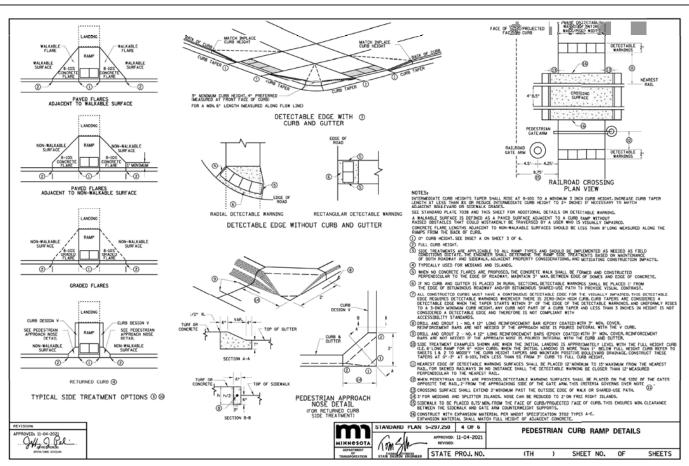



DF/

DAMON FARBER LANDSCAPE ARCHITECTS

310 South 4th Avenue, Suite 7050 Minneapolis, MN 55415 p: 612.332.7522



BOLTON & MENK

MANKATO, MN 56001-5900 p: 507.625.4171

LSON-RUDIE

NELSON-RUDIE & ASSOCIATES
9100 49TH AVE NORTH
MINNEAPOLIS, MN 55428

100% CONSTRUCTION


GORMAN PARK PHASE 1


 $\mathsf{ST.}\,\mathsf{PETER},\,\mathsf{MINNESOTA}$

Jeffrey A. Domras

I HEREBY CERTIFY THAT THIS PLAN, SPECIFICATION, OR REPORT WAS PREPARED ME OR UNDER MY DIRECT SUPERVISION AND THAT I AM A DULY LICENSED PROFESSIONAL ENGINEER UNDER THE LAWS OF THE STATE C

> MNDOT STANDARD PLANS

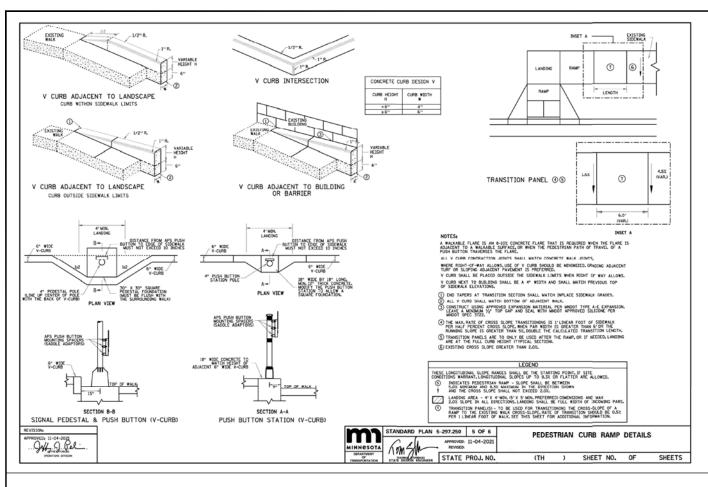

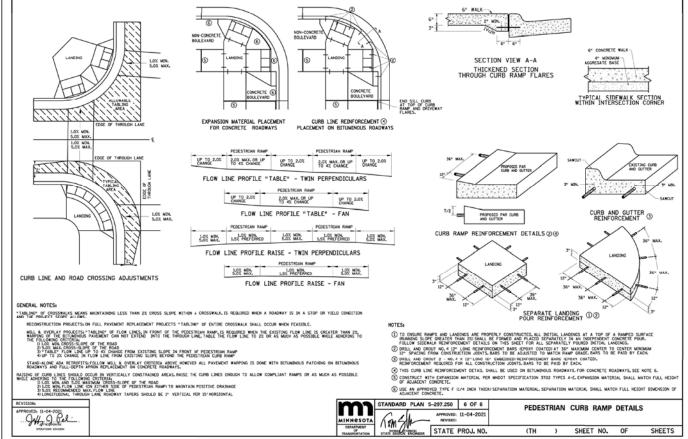



DF/

DAMON FARBER LANDSCAPE ARCHITECTS

310 South 4th Avenue, Suite 7050 Minneapolis, MN 55415 p: 612,332.7522



BOLTON & MENK 1960 PREMIER DRIVE MANKATO, MN 56001-5900 p: 507.625.4171

NELSON-RUDIE

NELSON-RUDIE & ASSOCIATES 9100 49TH AVE NORTH

9100 49TH AVE NORTH MINNEAPOLIS, MN 55428 612.669.4385

> 100% CONSTRUCTION DRAWINGS

GORMAN PARK PHASE 1

Jeffrey A. Domras

ST. PETER, MINNESOTA

I HEREBY CERTIFY THAT THIS PLAN, SPECIFICATION, OR REPORT WAS PREPARED I ME OR UNDER MY DIRECT SUPERVISION AND THAT I AM A DULY LICENSED PROFESSIONAL ENGINEER UNDER THE LAWS OF THE STATE OF

> MNDOT STANDARD PLANS

STORMWATER POLLUTION PREVENTION PLAN (SWPPP)

2025-2026 GORMAN PARK IMPROVEMENTS CITY OF SAINT PETER NICOLLET COUNTY, MINNESOTA



RESPONSIBLE PARTIES

The Contractor and Owner will be joint applicants under the MPCA's General Stormwater Permit for Construction Activity as required by the National Pollutant Discharge Elimination System (NPDES) Phase II program.

The Contractor shall provide one or more trained Construction SWPPP Manager(s) knowledgeable and experienced in the application of erosion prevention and sediment control BMPs that will oversee the implementation of the SWPPP, and the installation, inspection and maintenance of the erosion prevention and sediment control BMPs.

A Construction SWPPP Manager must be available for an on-site inspection within 72 hours upon request by the MPCA.

	COMPANY CONTACT PERSON		PHONE
OWNER:	City of Saint Peter	Pete Moulton	507-934-0670
SWPPP DESIGNER:	Bolton & Menk, Inc.	Joseph Smith, P.E.	507-625-4171
CONTRACTOR:	TBD TBD		TBD
CONSTRUCTION SWPPP MANAGER:	TBD	TBD	TBD
PARTY RESPONSIBLE FOR LONG TERM O&M:	City of Saint Peter	Pete Moulton	507-934-0670

The SWPPP Designer, Construction SWPPP Manager, and BMP Installer must have appropriate training. Documentation showing training commensurate with the job duties and responsibilities is required to be included in the SWPPP prior to any work beginning on the site. Training documentation for the SWPPP Designer is included on the Narrative sheet. The Contractor shall attach training documentation to this SWPPP for the Construction SWPPP Manager and BMP Installer prior to the start of construction. This information shall be kept up to date until the project NOT is filed.

ADDITIONAL COMPENSATION

Payment for all work associated with Erosion and Sediment Control shall be as described in the Project Manual. Unless otherwise authorized by the Owner no additional payment shall be made for any work required to administer and maintain the site erosion and sediment control in compliance with the Minnesota Pollution Control Agency (MPCA) - General Stormwater Permit for Construction Activity (MN R100001) including but not limited to inspection, maintenance, and removal of BMPs or addition of BMPs to accommodate Contractor phasing

DOCUMENT RETENTION

Permittees must make the SWPPP, including all inspection reports, maintenance records, training records and other information required by this permit, available to federal, state, and local officials within three (3) days upon request for the duration of the permit and for three (3) years following the NOT

GENERAL STORMWATER DISCHARGE REQUIREMENTS

All requirements listed in Section 5.1 of the Permit for the design of the permanent stormwater management system and discharge

- have been included in the preparation of this SWPPP. These include but are not limited to: The expected amount, frequency, intensity, and duration of precipitation
- The nature of stormwater runoff and run-on at the site
- Peak flow rates and stormwater volumes to minimize erosion at outlets and downstream channel and stream bank erosion
- The range of soil particle sizes expected to be present on the site.

Permanent stormwater treatment systems for this project have been designed in accordance with the guidance in the MN Stormwater Manual in place at the time of bidding. Copies of the design information and calculations are part of this SWPPP and will be provided in digital format upon written request to the Engineer.

LEGEND 1-MILE BOUNDARY PROJECT BOUNDARY IMPAIRED, SPECIAL OR PROTECTED WATERS NATIONAL WETLANDS INVENTORY RECEIVING WATERS DWSMA BOUNDRY, HIGH VULNERABILITY

Total Project Size (disturbed area) =	2.42	ACRES
Existing area of impervious surface =	0.31	ACRES
Post construction area of impervious surface =	0.60	ACRES
Total new impervious surface area created =	0.29	ACRES
		_

Planned Construction Start Date: **Estimated Construction Completion Date:** 10/30/2026

PERMANENT STORMWATER MANAGEMENT SYSTEM:

Type of storm water management used if more than 1 acre of new impervious surface is created

	Wet Sedimentation Basin
	Infiltration/Filtration
	Regional Pond
Х	Permanent Stormwater Management Not Required
	(<1 acre of impervious areas created)

PROJECT LOCATION:

COUNTY	TOWNSHIP	RANGE	SECTION	LATITUDE	LONGITUDE
Nicollet	T110N	R26W	21	44.32434°	-93.96355°

BMP SUMMARY	QUANTITY	UNIT
Stabilized Construction Exit	1	Lump Sum
Storm Drain Inlet Protection	5	Each
Perimeter Control	800	Lin Ft
Erosion Control Blanket	600	Sq Yd


DESCRIPTION OF CONSTRUCTION ACTIVITIES AND STORMWATER MANAGEMENT:

Construction activities include: Site grading, aggregate base, ADA improvements, concrete walk, storm sewer, water service, playground equipment, turf establishment, and temporary erosion and sediment

Stormwater in the are of the project is currently conveyed via grassy hills and shallow grassy swales. The grassy areas flow onto S 5th Street where stormwater enters the municipal storm sewer pipe networks. These pipe networks flow east and ultimately discharge to the Minnesota River.

After construction is complete stormwater drainage patterns will remain substantially uncharged.

 $Future\ improvements\ within\ Gorman\ Park\ include\ rain\ garden\ construction\ on\ the\ low\ area\ of\ the\ site\ to$ manage rate control and provide stormwater treatment prior to discharging to the municipal storm sewer pipe networks. These future improvements are intended to be constructed with the demolition of the existing Treemendous Playground, which is planned to occur in the near future.

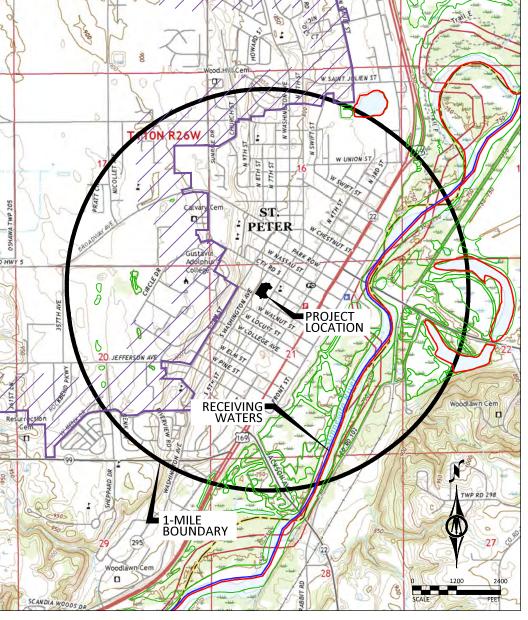

RECEIVING WATERS


Receiving waters, including surface water, wetlands, Public Waters, and stormwater ponds, within 1-mile of the project boundary are identified on the USGS 7.5 min quad map above. Receiving waters that are impaired, the impairment, and WLA are listed as follows. All specific BMPs relative to construction activities listed in the permit for special, prohibited, restricted, or impaired have been incorporated into this plan. All specific BMPs listed in approved TMDLs and those BMPs listed for construction related waste load allocations have also been incorporated.

NAME OF WATER BODY	TYPE (ditch, pond, wetland, lake, etc.)	Special, Prohibited, Restricted Water ¹	Flows to Impaired Water Within 1-Mile ²	USEPA Approved Construction Related TMDL ³
Minnesota River	River	No	Yes	Yes

Special, prohibited, and restricted waters are listed in Section 23 of the MN Construction Stormwater General Permit (MNR100001). dentified as impaired under section 303 (d) of the federal Clean Water Act for phosphorus, turbidity, TSS, dissolved oxygen, and/or aquatic biota.

IMPLEMENTATION SCHEDULE AND PHASING: The Contractor is required to provide an updated schedule and site management plan meeting the minimum requirements of Section 1717 of the Minnesota Standard Specifications for Construction.

- 1) Submit SWPPP Updates to Engineer. Submittal shall include any requested changes to the SWPPP, including but not limited to: Trained Personnel, Locations for Stockpiles, Concrete Washout, Sanitation Facilities, Types and Locations of Erosion & Sediment Control. Failure to submit updates shall be considered acceptance of the SWPPP as designed with no changes.
- 2) Install perimeter sediment control, inlet protection, and construction exit.
- Perform topsoil stripping, pavement removals, and other surface removals Construct underground utilities (watermain and storm sewer)
- Furnish and install rapid stabilization measures as needed at areas directly upstream of inlets
- Construct subgrade preparation and aggregate bases.
- Construct curb & gutter, sidewalks, and bituminous pavement
- 8) Place salvaged topsoil as needed and perform temporary and/or permanent seeding on disturbed areas.
- 9) Add additional temporary BMPs as necessary during construction based on inspection reports.
- 10) Ensure final stabilization measures are complete.
- 11) Provide digital copy of all Field SWPPP Documentation including Inspection Reports and SWPPP Revisions to the Owner
- 12) Submit Notice of Termination (NOT) to MPCA. NOTE: The NOT must be submitted to MPCA before Final Stabilization is considered complete.

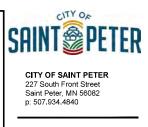

DAMON FARBER LANDSCAPE ARCHITECTS

310 South 4th Avenue, Suite 7050 Minneapolis, MN 55415

BOLTON & MENK

p: 612.332.7522

BOLTON & MENK

MANKATO, MN 56001-5900 p: 507.625.4171

NELSON-RUDIE & ASSOCIATES 9100 49TH AVE NORTH MINNEAPOLIS, MN 55428

CONSTRUCTION

GORMAN PARK

PHASE 1

ST. PETER, MINNESOTA

12/24/2024 0M1.133927

22-150

JAD/JPS

PER SHEET

100% CD SET

BMI Project #

DF/ Project #

Designed

REVISION

STORMWATER

POLLUTION

PREVENTION PLAN

PROJECT INFORMATION AND

LOCATION MAP

³ Construction Related TMDLs include those related to: phosphorus, turbidity, TSS, dissolved oxygen, and/or aquatic biota.

Information contained in this SWPPP narrative sheet summarizes requirements of the GENERAL PERMIT AUTHORIZATION TO DISCHARGE STORMWATER ASSOCIATED WITH CONSTRUCTION ACTIVITY UNDER THE NATIONAL POLLUTANT DISCHARGE ELIMINATION SYSTEM/STATE DISPOSAL SYSTEM PROGRAM - Permit No: MN RI00001 (Permit) as they apply to this project. All provisions of the Permit including those not specifically cited herein shall apply to this project. The Contractor is responsible to be familiar with and comply with all conditions of the permit. The full text of the Permit is available at: https://www.pca.state.mn.us/sites/default/files/wq-strm2-80a.pdf

SWPPP AMENDMENTS AND SUBMITTALS

Contractor must prepare and submit to the Engineer a SWPPP amendment as necessary to include additional Best Management Practices (BMPs) to correct problems identified or address the following situations.

- 1. Contact information and training documentation for Construction SWPPP Manager and BMP Installer,
- There is a change in construction method of phasing, operation, maintenance, weather or seasonal conditions not anticipated during the design of the SWPPP including but not limited to:
 - a. Types and/or Locations of BMPs
 - b. Material Storage and Spill Response
 - c. Fueling Plans
 - d. Locations for Stockpiles, Concrete Washout, and Sanitation Facilities and
 - e. Project Phasing
- 3. It is determined that the SWPPP is not achieving objectives of minimizing pollutants in stormwater discharges associated with construction activity, or
- 4. The SWPPP is not consistent with the terms and conditions of the permit.

The Contractor may implement SWPPP amendments immediately and is not required to wait for Engineer review of the submittal The responsibility for completeness of SWPPP amendments and compliance with the Permit lies with the Contractor. Review, comment, or lack of comment by the Engineer on a SWPPP amendment shall not absolve the responsibilities of the Contractor in any way.

If a change order is issued for a design change the SWPPP amendment will be prepared by the Engineer and included in the change order.

In addition to SWPPP amendments, the Contractor shall submit to the Engineer Weekly Erosion and Sediment Control Schedule meeting the requirements of MnDOT 1717.

The Contractor shall keep copies of all SWPPP amendments, Weekly Erosion and Sediment Control Schedules, inspection logs, and maintenance logs with the field copy of the SWPPP. A PDF copy of these documents will be provided along with a copy of the final Field Copy of the SWPPP to the Engineer along with the signed Notice of Termination when final stabilization is complete.

EROSION PREVENTION PRACTICES

Stormwater conveyance channels shall be routed around unstabilized areas. Erosion controls and velocity dissipation devices shall be used at outlets within and along the length of any constructed conveyance channel.

The normal wetted perimeter of all ditches or swales, including storm water management pond slopes, that drain waters from the site must be stabilized within 200' of any property edge or discharge point, including storm sewer inlets, within 24 hours of

Temporary or permanent ditches or swales used as sediment containment during construction do not need to be stabilized during temporary period of use and shall be stabilized within 24 hours after no longer used as sediment containment.

Mulch, hydromulch, tackifier, or similar practice shall not be used in any portion of the wetted perimeter of a temporary or permanent drainage ditch or swale section with a continuous slope of greater than 2 percent.

Energy dissipation shall be installed at all temporary or permanent pipe outlets within 24 hours of connection to a surface water or permanent stormwater treatment system.

The Contractor shall phase construction and use construction methods to the extent practical to minimize exposed soils. The project phasing shall be documented in the Weekly Erosion and Sediment Control Schedule.

SEDIMENT CONTROL PRACTICES

Down gradient BMPs including perimeter BMPs must be in place before up gradient land- disturbing activities begin and shall remain in place until final stabilization.

All BMPs that have been adjusted or removed to accommodate short-term activities shall be re-installed or replaced the earlier of the end of the work day or before the next precipitation event even if the activity is not complete.

Inlet BMPs may be removed for specific safety concerns. The BMPs shall be replaced as soon as the safety concern is resolved. The removal shall be documented in the SWPPP as a SWPPP amendment.

Temporary stockpiles must have sediment control BMPs. The Contractor shall prepare and submit to the Engineer a SWPPP amendment showing the location of temporary stockpiles and the BMPs for each stockpile. The SWPPP amendment must meet the minimum requirements of Section 9 of the Permit.

Soil compaction shall be minimized and topsoil shall be preserved, unless infeasible or if construction activities dictate soil compaction or topsoil stripping.

The use of polymers, flocculants, or other sedimentation treatment chemicals are not proposed as part of this SWPPP as designed by the Engineer. If methods or phasing of construction require the use of any of these chemicals, the Contractor shall prepare and submit to the Engineer a SWPPP amendment that meets the minimum requirements of Section 9 of the Permit.

TEMPORARY SEDIMENTATION BASINS

A temporary sedimentation basin has not been included in this SWPPP as designed by the Engineer. If a basin is later determined to be desirable or necessary the Contractor shall prepare and submit to the Engineer a SWPPP amendment. Temporary sedimentation basins shall meet or exceed the minimum requirements of Section 14 of the Permit and shall include a basin draining plan meeting or exceeding the minimum requirements of Section 10 of the Permit. Where the site discharges to Special and/or Impaired Waters the SWPPP amendment shall also meet or exceed the minimum requirements of Section 23 of the permit.

DEWATERING

A dewatering plan has not been included in this SWPPP as designed by the Engineer. If dewatering is required for this project, the Contractor shall prepare and submit to the Engineer a SWPPP amendment. All dewatering shall meet or exceed the minimum requirements of Section 10 of the Permit.

POLLUTION PREVENTION

Products and materials that have the potential to leach pollutants that are stored on the site must be stored in a manner designed to minimize contact with stormwater. Materials that are not a source of potential contamination to stormwater or that are designed for exposure to stormwater are not required to be covered.

Hazardous materials including but not limited to pesticides, fertilizer, petroleum products, curing compounds and toxic waste must be properly stored and protected from stormwater exposure as recommended by the manufacturer in an access restricted area.

Solid waste must be stored, collected and disposed of in compliance with Minnesota Administrative Rules Chapter 7035.

Portable toilets must be positioned so that they are secure and will not be tipped or knocked over. Sanitary waste must be disposed of properly in accordance with Minn. R. CH 7041.

Exterior vehicle or equipment washing on the project site shall be limited to a defined area of the site. No engine degreasing is allowed on site. A sign must be installed adjacent to each washout facility that requires site personnel to utilize the proper facilities for disposal of concrete and other washout wastes.

The Contractor shall prepare and submit a SWPPP amendment detailing the location and BMPs proposed for storage of materials, solid waste, portable toilets, and exterior vehicle or equipment washing on the site. The SWPPP amendment shall include a spill prevention and response plan that is appropriate for the materials proposed to be on the site. The SWPPP amendment shall meet or exceed the minimum requirements of Section 12 of the Permit.

INSPECTION & MAINTENANCE

A trained person shall routinely inspect the entire construction site at the time interval indicated on this sheet of the SWPPP during active construction and within 24-hours after a rainfall event greater than 0.5 inches in 24 hours. Following an inspection that occurs within 24-hours after a rainfall event, the next inspection must be conducted at the time interval indicated in the Receiving Waters Table found on the SITE PLAN AND INFORMATION SHEET of the SWPPP.

All inspections and maintenance conducted during construction must be recorded on the day it is completed and must be retained with the SWPPP. Inspection report forms are available in the Project Specifications. Inspection report forms other than those provided shall be approved by the engineer.

The Contractor may request a change in inspection schedule for the following conditions:

- a. Inspections of areas with permanent cover to be reduced to once per month,
- b. Inspections of areas that have permanent cover and have had no construction activity for 12 months to be suspended until construction resumes.
- c. Inspections of areas where construction is suspended due to frozen ground conditions, inspections to be suspended until the earlier of within 24 hours of runoff occurring, or upon resuming construction.

No change in inspection schedule shall occur until authorized by the Engineer

Inspections must include

- 1. All erosion prevention and sediment control BMPs and Pollution Prevention Management Measures to ensure integrity and effectiveness.
- 2. Surface waters, including drainage ditches and conveyance systems for evidence of erosion and sediment deposition.
- 3. Construction site vehicle exit locations, streets and curb and gutter systems within and adjacent to the project for sedimentation from erosion or tracked sediment from vehicles.
- 4. Infiltration areas to ensure that no sediment from ongoing construction activity is reaching the infiltration area and that equipment is not being driven across the infiltration area.

 All non-functioning BMPs and those BMPs where sediment reaches one-half (1/2) of the depth of the BMP, or in the case of

All non-tunctioning BMPs and those BMPs where sediment reaches one-half (1/2) of the depth of the BMP, or in the case of sediment basins one-half (1/2) of the storage volume, must be repaired, replaced, or supplemented by the end of the next business day after discovery, or as soon as field conditions allow.

Permittees must repair, replace or supplement all nonfunctional BMPs with functional BMPs by the end of the next business day after discovery, or as soon as field conditions allow.

Any sediment that escapes the site must be removed and the area stabilized within 7 calendar days of discovery unless precluded by legal, regulatory, or physical access in which case the work shall be completed within 7 calendar days of authorization. Paved surfaces such as streets shall have any escaped or tracked sediment removed by the end of the day that it is discovered. Sediment release, other than paved surfaces that can be cleaned up with street sweeping shall be reported immediately upon discovery to the Engineer.

PUBLIC WATER RESTRICTIONS:

For public waters that have been promulgated "work in water restrictions" during fish spawning time frames, all exposed soil areas that are within 200 feet of the water's edge, and drain to these waters must complete stabilization within 24-hours during the time period. MN DNR permits are not valid for work in waters that are designated as infested waters unless accompanied by an Infested Waters Permit or written notification has been obtained from MN DNR stating that such permit is not required. There is no exception for pre-existing permits. If a MN DNR Permit has been issued for the project and the water is later designated as infested, the Contractor shall halt all work covered by the MN DNR Permit until an Infested Waters Permit is obtained or that written notification is obtained stating that such permit is not required.

FINAL STABILIZATION

Final Stabilization is not complete until all the following requirements have been met:

- $1. \ Substantial \ Completion \ has been \ reached \ and \ no \ ground \ disturbing \ activities \ are \ anticipated$
- Permanent cover has been installed with an established minimum uniform perennial vegetation density of 70 percent of its expected final growth. Vegetation is not required in areas where no vegetation is proposed by this project such as impervious surfaces or the base of a sand filter.

- 3. Accumulated sediment has been removed from all permanent stormwater treatment systems as necessary to ensure the system is operating as designed.
- 4. All sediment has been removed from conveyance system
- 5. All temporary synthetic erosion prevention and sediment control BMPs have been removed. BMPs designated on the SWPPP to remain to decompose on-site may remain.
- 6. For residential construction only, permit coverage terminates on individual lots if the structures are finished and temporary erosion prevention and downgradient perimeter control is complete, the residence sells to the homeowner, and the permittee distributes the MPCA's "Homeowner Fact Sheet" to the homeowner.
- 7. For agricultural land only (e.g., pipelines across cropland), the disturbed land must be returned to its preconstruction agricultural use prior to submitting the NOT.

SITE STABILIZATION COMPLETION:

Stabilization of exposed soils shall begin immediately and shall be	
completed after the construction activity has temporarily or	7 calendar days
permanently ceased no later than:	•

SITE INSPECTION INTERVAL

A trained person shall routinely inspect the entire construction site during active construction at an interval of no more than:	3 calendar days
	3 calendar days

SPECIAL ENVIRONMENTAL CONSIDERATIONS AND PERMITS:

1)	Was an environmental review required for this project or any part of a common plan of development or sale that includes all or any portion of this project?	NC
2)	Does any portion of the site have the potential to affect threatened or endangered species or their critical habitat?	NC
3)	Does any portion of this site discharge to a Calcareous fen.	NO
4)	Will any portion of the site potentially affect properties listed on the National Register of Historic Places or a known or discovered archeological site?	NC
5)	Have any Karst features have been identified in the project vicinity?	NO
6)	Is compliance with temporary or permanent stormwater management design requirements infeasible for this project?	NC
7)	Has the MN DNR promulgated "work in water restrictions" for any Public Water this site disharges to during fish spawning?	NO

TYPE OF PERMIT	PERMITTING AGENCY	PERMIT STATUS AND CONDITIONS
Construction Stormwater NPDES	MPCA	(contractor to apply for permit)

SWPPP DESIGNER TRAINING DOCUMENTATION

University of Minnesota Joe P. Smith

Design of Construction SWPPP (May 31 2026)

Erosion and Stormwater Management

The bearer of this card has been tested and is certified in the area(s) shown on the reverse of this card. Certification expiration dates appear after each certification area.



SAINT PETER

CITY OF SAINT PETER 227 South Front Street Saint Peter, MN 56082 p: 507.934.4840

DF/
DAMON FARBER LANDSCAPE ARCHITECTS

310 South 4th Avenue, Suite 7050 Minneapolis, MN 55415 p: 612.332.7522



BOLTON & MENK 1960 PREMIER DRIVE MANKATO, MN 56001-5900 p: 507.625.4171

NELSON-RUDIE
NELSON-RUDIE & ASSOCIATES

9100 49TH AVE NORTH MINNEAPOLIS, MN 55428

> 100% CONSTRUCTION

GORMAN PARK PHASE 1

ST. PETER, MINNESOTA

I HEREBY CERTIFY THAT THIS PLAN, SPECIFICATION, OR REPORT WAS PREPARED ME OR UNDER MY DIRECT SUPERVISION AND THAT I AM A DULY LICENSED PROFESSIONAL ENGINEER UNDER THE LAWS OF THE STATE C MINNESOTA.

Name Jeffrey A. Domr Registration # 264

 100% CD SET
 12/24/2024

 BMI Project #
 0M1.133927

 DF/ Project #
 22-150

 Scale
 PER SHEET

 Designed
 JADJ/JPS

 Drawn
 JPS

 Checked
 JAD

REVISION

STORMWATER
POLLUTION
PREVENTION PLAN
NARRATIVE





::::::


PROJECT BOUNDARY



SOIL TYPE

STEEP SLOPES (>33.3%)



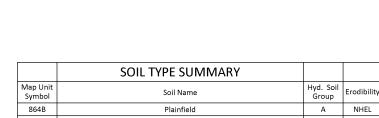

NHEL - Not Highly Erodible Land PHEL - Potentially Highly Erodible Land HEL - Highly Erodible Land



CITY OF SAINT PETER 227 South Front Street Saint Peter, MN 56082 p: 507.934.4840

DF/

DAMON FARBER LANDSCAPE ARCHITECTS

310 South 4th Avenue, Suite 7050 Minneapolis, MN 55415 p: 612,332,7522



BOLTON & MENK 1960 PREMIER DRIVE MANKATO, MN 56001-5900 p: 507.625.4171

NELSON-RUDIE

NELSON-RUDIE & ASSOCIATES 9100 49TH AVE NORTH MINNEAPOLIS, MN 55428 612.669.4385


> 100% CONSTRUCTION DRAWINGS

GORMAN PARK PHASE 1


ST. PETER, MINNESOTA

I HEREBY CERTIFY THAT THIS PLAN, SPECIFICATION, OR REPORT WAS PREPARED B ME OR UNDER MY DIRECT SUPERVISION AND THAT I AM A DULY LICENSED PROFESSIONAL ENGINEER UNDER THE LAWS OF THE STATE OF MINNESOTA.

STORMWATER
POLLUTION
PREVENTION PLAN
SITE AND SOILS MAP

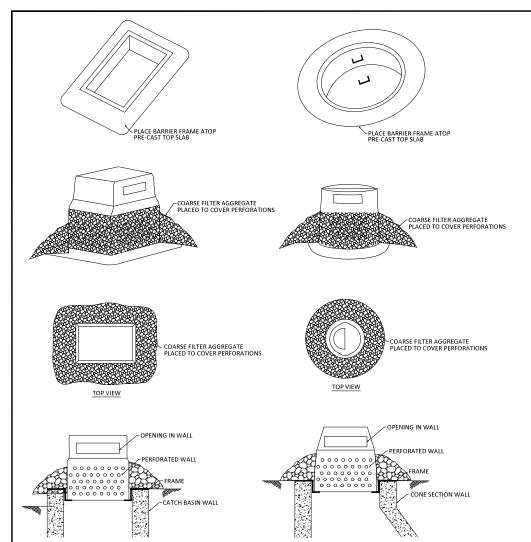



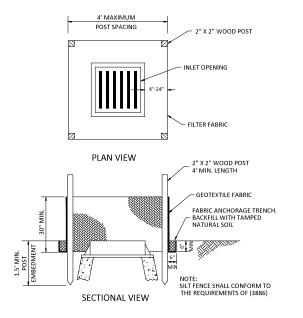


2' X 3' STRUCTURE

EROSION CONTROL BARRIER

SAINT PETER STANDARD


PLATE 3016

INLET PROTECTION - PRE ASSEMBLED SAINT PETER STANDARD **PLATE 3011**

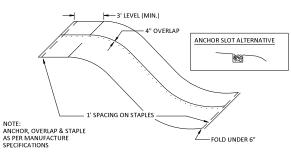


EROSION CONTROL BLANKET INSTALLATION

SAINT PETER STANDARD **PLATE 3008**

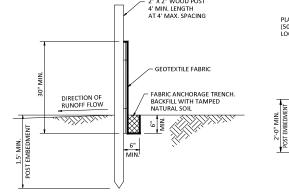


SILT FENCE - PRE ASSEMBLED SAINT PETER STANDARD **PLATE 3004**

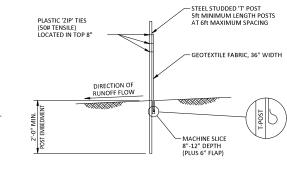


SILT FENCE - MACHINE SLICED NOT TO SCALE

SAINT PETER STANDARD PLATE 3006

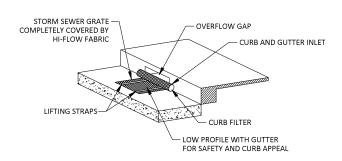

CURB INLET (WITH GRATE) PROTECTION SEDIMÈNT CONTROL DEVICE

NOT TO SCALE SAINT PETER STANDARD **PLATE 3025**

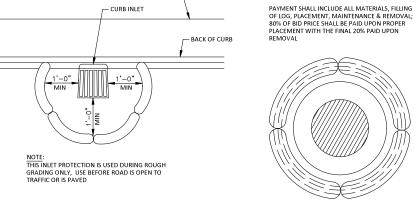


BACK OF SIDEWALK-

— CURB INLET


	WITH 45 LBS. ED AGGREGATE SOUND, DURABLE
PARTICLES OF C	CRUSHED QUARRY EL CONFORMING VING GRADATION.

GRADATION						
SIEVE SIZE PERCENT PASSING						
1 1/2"	100					
1"	95-100					
3/4"	65-95					
3/8"	30-65					
NO 4	10-35					
NO 10	3-20					
NO 40	0-8					
NO 200	0-3					

NOTE: CRUSHED CONCRETE OR BITUMINOUS SHALL NOT BE USED FOR OPEN

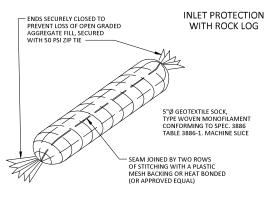

INLET PROTECTION ROCK BAG SAINT PETER STANDARD PLATE 3015

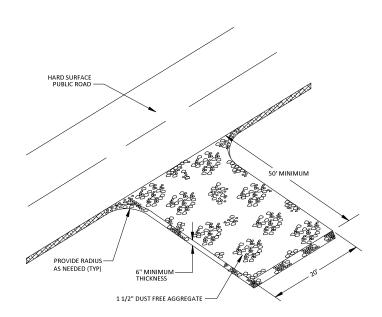

RESIDENTIAL EROSION CONTROL AT CONSTRUCTION SITE ENTRANCE

NOT TO SCALE
SAINT PETER STANDARD PLATE 3005R



CITY OF SAINT PETER 227 South Front Street Saint Peter, MN 56082 p: 507.934.4840

DAMON FARBER LANDSCAPE ARCHITECTS

310 South 4th Avenue, Suite 7050 Minneapolis, MN 55415 p: 612.332.7522



BOLTON & MENK 1960 PREMIER DRIVE MANKATO, MN 56001-5900 p: 507.625.4171

NELSON-RUDIE & ASSOCIATES 9100 49TH AVE NORTH MINNEAPOLIS, MN 55428 612.669.4385


CONSTRUCTION

GORMAN PARK PHASE 1

ST. PETER, MINNESOTA

Registration #	26464
Leffry A. Dos	mos 12/24/2024
JEFFREY A. DOMRAS	Date
100% CD SET	12/24/2024
BMI Project #	0M1.133927
DF/ Project #	22-150
Scale	PER SHEET
Designed	JAD/JPS
Drawn	JPS
Checked	JAD
REVISION	

STORMWATER POLLUTION PREVENTION PLAN BMP DETAILS

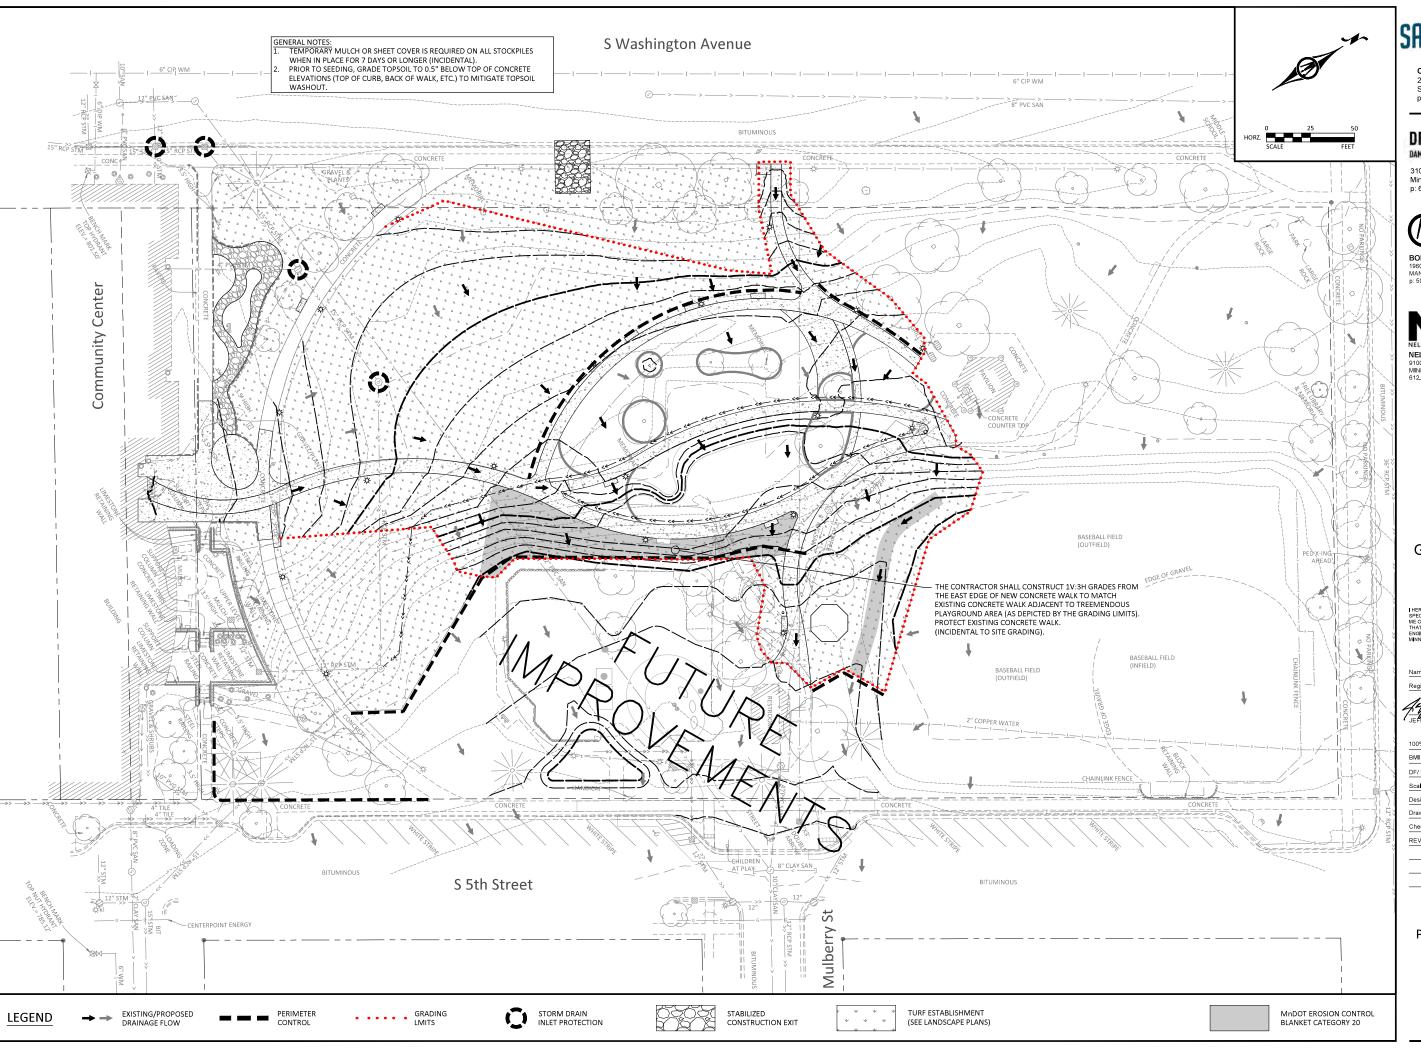



DF/

DAMON FARBER LANDSCAPE ARCHITECTS

310 South 4th Avenue, Suite 7050 Minneapolis, MN 55415 p: 612,332,7522



BOLTON & MENK 1960 PREMIER DRIVE MANKATO, MN 56001-5900 p: 507.625.4171

NELSON-RUDIE & ASSOCIATES 9100 49TH AVE NORTH MINNEAPOLIS, MN 55428 612.669.4385

100% CONSTRUCTION


GORMAN PARK PHASE 1

ST. PETER, MINNESOTA

100% CD SET 12/24/2024 0M1.133927 BMI Project # DF/ Project # 22-150 PER SHEET Designed JAD/JPS REVISION

STORMWATER **POLLUTION** PREVENTION PLAN

EROSION & SEDIMENT CONTROL PLAN

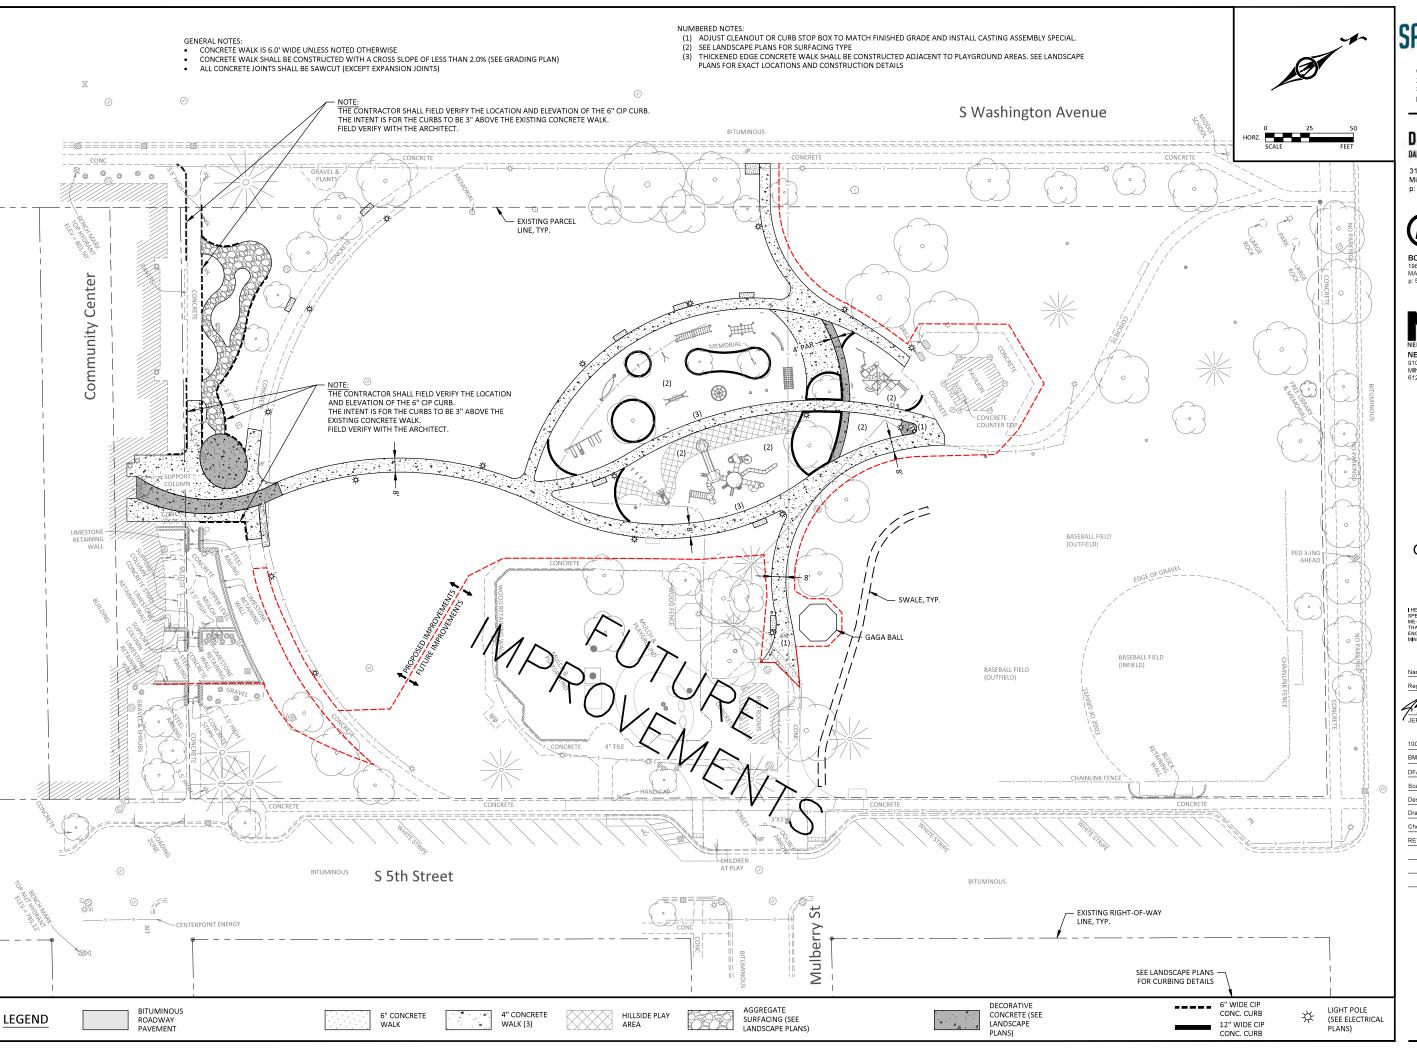



DF/

DAMON FARBER LANDSCAPE ARCHITECTS

310 South 4th Avenue, Suite 7050 Minneapolis, MN 55415 p: 612,332,7522



BOLTON & MENK 1960 PREMIER DRIVE MANKATO, MN 56001-5900 p: 507.625.4171

NR

NELSON-RUDIE & ASSOCIATES 9100 49TH AVE NORTH MINNEAPOLIS, MN 55428 612.669.4385

> 100% CONSTRUCTION

GORMAN PARK PHASE 1

ST. PETER, MINNESOTA

IEREBY CERTIFY THAT THIS PLAN,
PECIFICATION, OR REPORT WAS PREPARED BY
E OR UNDER MY DIRECT SUPERVISION AND
HAT I AM A DULY LICENSED PROFESSIONAL

Name Jeffrey A. Domras

Registration # 26464

Jeffrey A. Dommar 12/24/2024

Jeffrey A. DOMRAS Date

100% CD SET 12/24/2024

 100% CD SET
 12/24/2024

 BMI Project #
 0M1.133927

 DF/ Project #
 22-150

 Scale
 PER SHEET


 Designed
 JAD/JPS

 Drawn
 JPS

 Checked
 JAD

 REVISION
 —

SITE PLAN

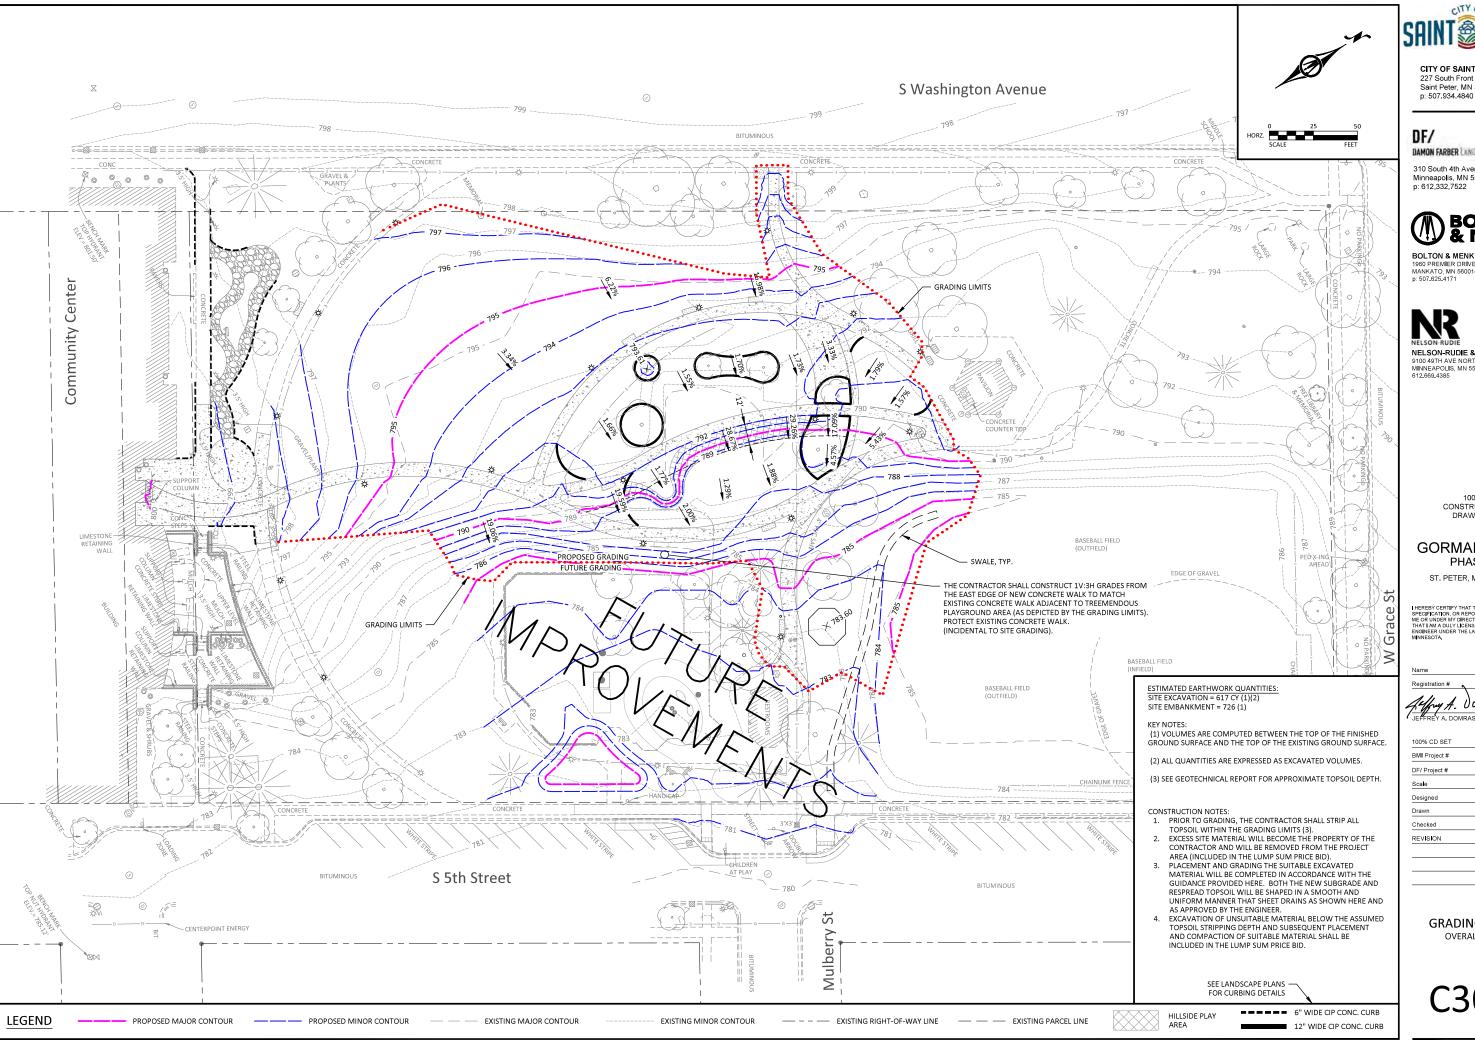



DAMON FARBER LANDSCAPE ARCHITECTS

310 South 4th Avenue, Suite 7050 Minneapolis, MN 55415



1960 PREMIER DRIVE MANKATO, MN 56001-5900 p: 507.625.4171

NELSON-RUDIE & ASSOCIATES 9100 49TH AVE NORTH MINNEAPOLIS, MN 55428 612.669.4385


100% CONSTRUCTION

GORMAN PARK PHASE 1

ST. PETER, MINNESOTA

12/24/2024 0M1.133927 22-150 PER SHEET JAD/JPS

> **GRADING PLAN** OVERALL SITE

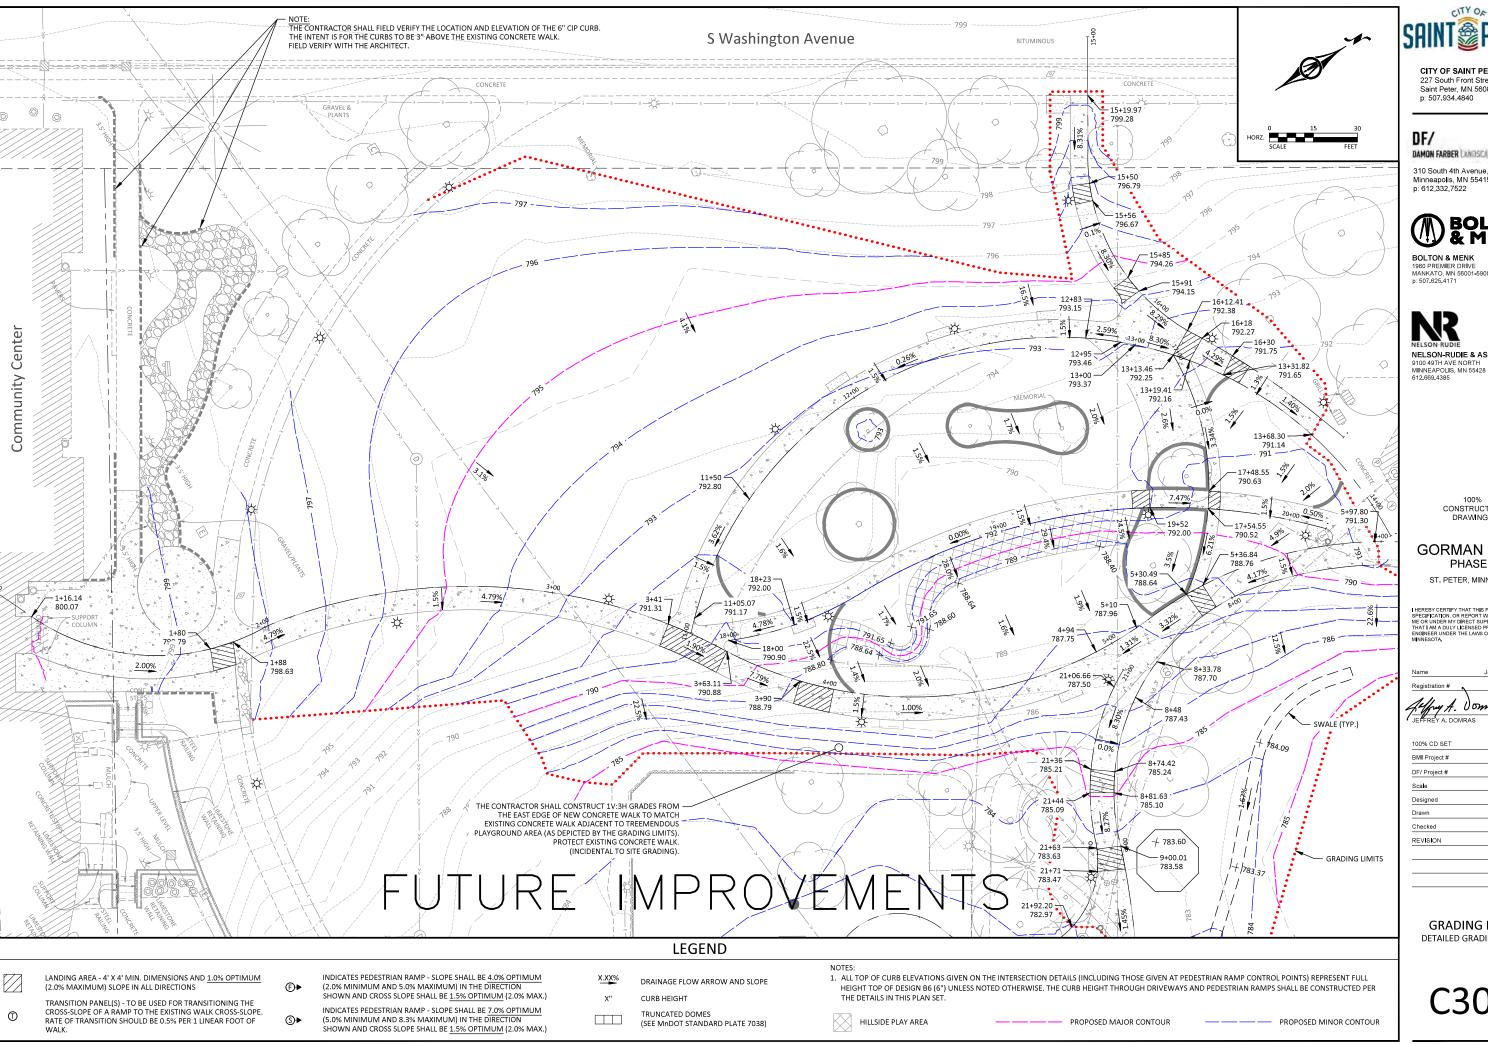

SAINT PETER

CITY OF SAINT PETER 227 South Front Street Saint Peter, MN 56082 p: 507.934.4840

DAMON FARBER LANDSCAPE ARCHITECTS

310 South 4th Avenue, Suite 7050 Minneapolis, MN 55415 p: 612,332,7522



1960 PREMIER DRIVE MANKATO, MN 56001-5900 p: 507.625.4171

NELSON-RUDIE & ASSOCIATES


100% CONSTRUCTION

GORMAN PARK PHASE 1

ST. PETER, MINNESOTA

12/24/2024 0M1.133927 22-150 PER SHEET JAD/JPS

GRADING PLAN DETAILED GRADING PLAN

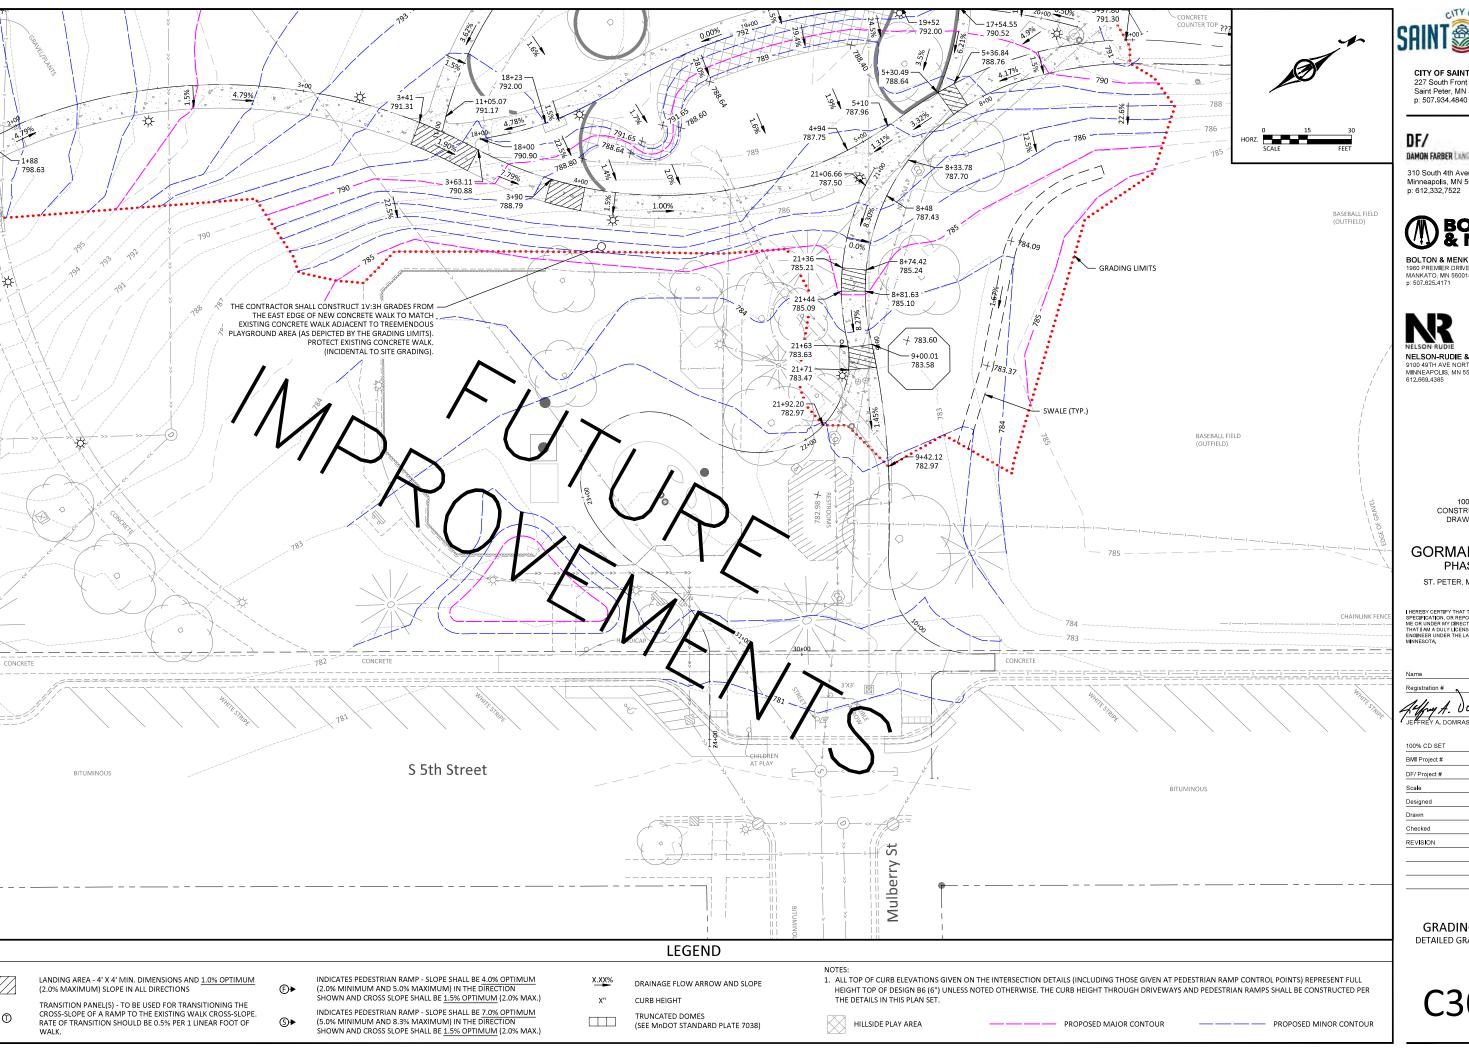

SAINT PETER

CITY OF SAINT PETER 227 South Front Street Saint Peter, MN 56082 p: 507.934.4840

DAMON FARBER LANDSCAPE ARCHITECTS

310 South 4th Avenue, Suite 7050 Minneapolis, MN 55415 p: 612.332.7522



1960 PREMIER DRIVE MANKATO, MN 56001-5900 p: 507.625.4171

NELSON-RUDIE & ASSOCIATES 9100 49TH AVE NORTH MINNEAPOLIS, MN 55428 612.669.4385

100% CONSTRUCTION


GORMAN PARK PHASE 1

ST. PETER, MINNESOTA

12/24/2024 0M1.133927

22-150 PER SHEET JAD/JPS

GRADING PLAN DETAILED GRADING PLAN

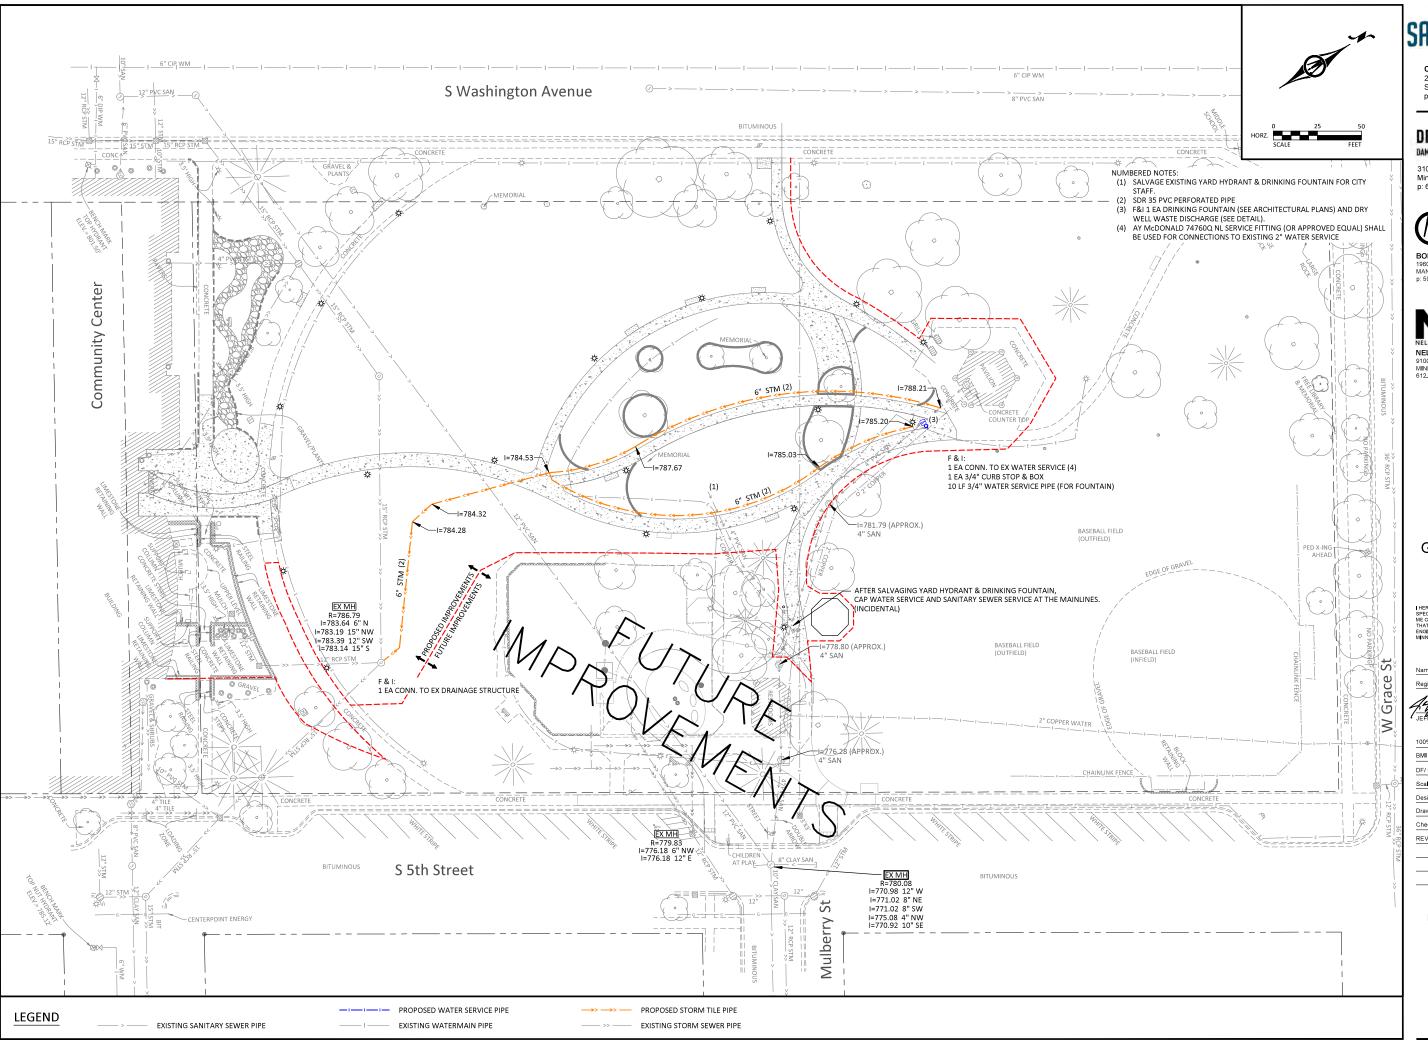



DF/

DAMON FARBER LANDSCAPE ARCHITECTS

310 South 4th Avenue, Suite 7050 Minneapolis, MN 55415 p: 612,332,7522



BOLTON & MENK 1960 PREMIER DRIVE MANKATO, MN 56001-5900 p: 507.625.4171

NS

NELSON-RUDIE & ASSOCIATES 9100 49TH AVE NORTH MINNEAPOLIS, MN 55428 612.669.4385

> 100% CONSTRUCTION

GORMAN PARK PHASE 1

 $\mathsf{ST.}\,\mathsf{PETER}, \mathsf{MINNESOTA}$

EREBY CERTIFY THAT THIS PLAN, ECIFICATION, OR REPORT WAS PREPARED BY OR UNDER MY DIRECT SUPERVISION AND AT I AM A DULY LICENSED PROFESSIONAL GINEER UNDER THE LAWS OF THE STATE OF

 Name
 Jeffrey A. Domras

 Registration #
 26464

 100% CD SET
 12/24/2024

 BMI Project #
 0M1.133927

 DF/ Project #
 22-150

 Scale
 PER SHEET


 Designed
 JAD/JPS

 Drawn
 JPS

 Checked
 JAD

 REVISION

UTILITY PLAN

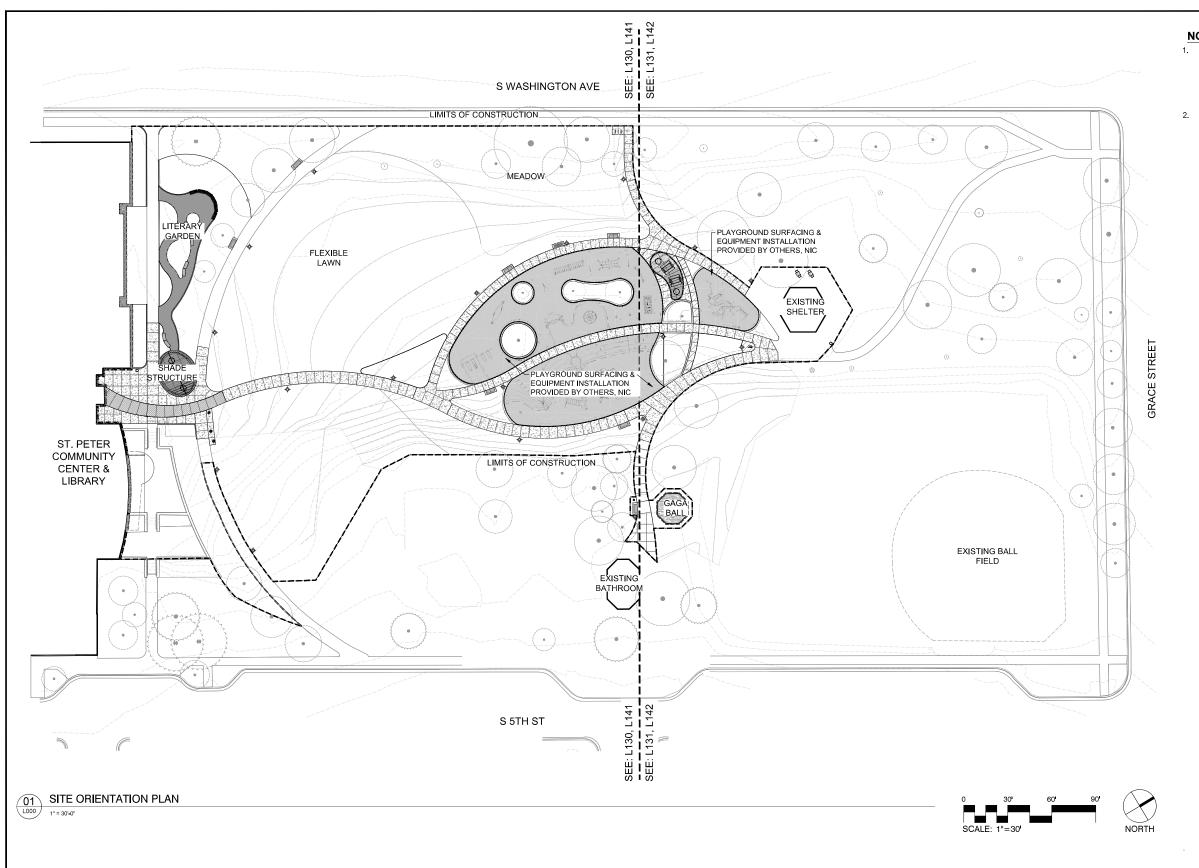

NOTES

- 1. CITY OF SAINT PETER IS IN DIRECT CONTRACT WITH PLAY MANUFACTURER. CONTRACTOR IS RESPONSIBLE FOR ALL COORDINATION EFFORTS WITH PLAY MANUFACTURER TO
 ENSURE SITE PREPARATION IS COMPLETE AND
 ON SCHEDULE FOR INSTALLATION OF SURFACE
- ON SCHEDULE FOR INSTALLATION OF SURFACE AND EQUIPMENT.

 2. CONTRACTOR TO EXCAVATE AND HOLD DOWN SUBGRADE FOR PLAY SURFACING INSTALLATION. REFER TO PLAY CONTAINER SECTIONS L400.



CITY OF SAINT PETER 227 South Front Street Saint Peter, MN 56082 p: 507.934.4840

DAMON FARBER LANDSCAPE ARCHITECTS

310 South 4th Avenue, Suite 7050 Minneapolis, MN 55415 p: 612 332 7522



BOLTON & MENK 1960 PREMIER DRIVE MANKATO, MN 56001-5900 p: 507.625.4171

NELSON-RUDIE & ASSOCIATES
9100 49TH AVE NORTH
MINNEAPOLIS, MN 55428
612,669,4385

100% CONSTRUCTION DRAWINGS

GORMAN PARK

ST. PETER, MINNESOTA

I hereby certify that this document was prepared by me or under my direct supervision and that I am a duly licensed Landscape Architect under the laws of the State of Minnesota.

12/24/2024 100% CD SET 12/24/2024 DF/ Project # 22-150

> PER SHEET AG/RP/JR/JM

REVISION

Drawn/Checked

Scale

Registration#

SITE **ORIENTATION** PLAN

REFER	RENCE NOTES SCHEDULE	1						
CODE AMENITY	DESCRIPTION	DETAIL	MATERIAL PROFILE/ASSEMBLY	MANUFACTURER	PRODUCT/MODEL PRODUCT/MODEL	COLOR/FINISH	COMMENTS	SPEC#
AM-01	SITE AMENITY TYPE 1 - COMMUNITY CENTER SHADE PAVILION	1/L503	30'X24' OVAL STEEL AND THERMALLY MODIFIED ASH PAVILION	NEU DESIGN OR APPROVED PRODUCT	NEU DESIGN OR APPROVED PRODUCT	V-SHAPED STEEL SQUARE TUBE COLUMNS, STEEL BEAM GRID STRUCTURE WITH THERMALLY MODIFIED ASH SLATS		32 33 00 - SITE FURNISHINGS
AM-02	SITE AMENITY TYPE 2 - PLAYGROUND SHADE PAVILION	2/L503	36'X14' ORGANIC SHAPED ALUMINUM AND THERMALLY MODIFIED ASH PAVILION	NEU DESIGN OR APPROVED PRODUCT	NEU DESIGN OR APPROVED PRODUCT	V-SHAPED STEEL SQUARE TUBE COLUMNS, ALUMINUM BEAM GRID STRUCTURE WITH THERMALLY MODIFIED ASH SLATS		32 33 00 - SITE FURNISHING
AM-04	SITE AMENITY TYPE 04 - EXISTING GRILL - RELOCATE	N/A	EXISTING GRILL				RELOCATE EXISTING GRILL WHERE SHOW ON PLANS	
CODE	DESCRIPTION	DETAIL	MATERIAL PROFILE/ASSEMBLY	COLOR/FINISH	SPEC#			
CURB	TOURD TYPE 4 OF CONORETE	TE# 500	TOURNAY OF DEFINIOUS CONCERNS OF DEPONIES	LOTANDA DO ODAY CONODETE MATOU EINIOU	32 16 14 - CURBS, GUTTERS, AND DRIVEWAYS			
CB-01	CURB TYPE 1 - 6" CONCRETE	5/L500	6" W X 9" D FLUSH CONCRETE CURB OVER COMPACTED CLASS V AGGREGATE BASE AND COMPACTED SUBGRADE	OF EXISTING CURBS ON SITE	32 16 14 - CURBS, GUTTERS, AND DRIVEWATS			
CB-02	CURB TYPE 2 - 12" CONCRETE	6/L500	12" W X 8" D REINFORCED FLUSH CONCRETE CURB OVER COMPACTED CLASS V AGGREGATE BASE AND COMPACTED SUBGRADE	STANDARD GRAY CONCRETE, MATCH FINISH OF EXISTING CURBS ON SITE				
EDGING		_	COBOTABL			-		
ED-01	EDGING TYPE 1 - STEEL EDGER	8/L500	3/16" STEEL EDGING WITH STAKES	BLACK	32 93 00 - PLANTS			
CODE	DESCRIPTION	DETAIL	MATERIAL PROFILE/ASSEMBLY	MANUFACTURER	PRODUCT/MODEL	COLOR/FINISH	SPEC#	
MINERAL MU	JLCH					•		
MM-01	MINERAL MULCH TYPE 01 - MAINTENANCE STRIP	9/L500	1 1/2" DECORATIVE TRAP ROCK OVER GEOTEXTILE FABRIC	DRESSER TRAP (OR SIMILAR)	1 1/2" DECORATIVE ROCK	CLEAN WASHED	32 93 00 - PLANTS	
PAVING		Ten 500	LOGUEDETE MALL COST ON THE		TOTAL DE CONCESTO	Top of or to op its to the top its to	100 10 00 10 00 100 100 100 100 100 100	
P-01A	PAVING TYPE 01A - DECORATIVE CONCRETE PAVING		CONCRETE WALK, SEE CIVIL		STANDARD CONCRETE	TOP CAST #3 OR #5 TO MATCH EXISTING CONCRETE PATH CONDITION, CONTRACTOR TO PROVIDE MOCKUP FOR LANDSCAPE ARCHITECT APPROVAL	32 16 23.13 - CONCRETE WALKS	
P-01B	PAVING TYPE 01B - DECORATIVE CONCRETE PAVING THICKENED EDGE	2/L500	10" THICKENED EDGE ALONG 4" REINFORCED CONCRETE PAVING ,SEE CIVIL		DECORATIVE CONCRETE PAVING WITH TOPCAST FINISH	TOP CAST #3 OR #5 TO MATCH EXISTING CONCRETE PATH CONDITION, CONTRACTOR TO PROVIDE MOCKUP FOR LANDSCAPE ARCHITECT APPROVAL	32 13 16 - DECORATIVE CONCRETE PAVING	
P-02		2/L500	DECORATIVE CONCRETE PAVING OVER SUBBASE OVER COMPACTED SUBGRADE		DECORATIVE CONCRETE PAVING WITH TOPCAST FINISH	TOPCAST #25 FINISH WITH SAWCUT JOINTS	32 13 16 - DECORATIVE CONCRETE PAVING	
P-05	PAVING TYPE 05 - DECOMPOSED GRANITE	3/L500	STABILIZED PATHWAY AGGREGATE CRUSHED TO 1/4" MINUS WITH FINES ON COMPACTED AGGREGATE BASE & SUBGRADE	KAFKA GRANITE, OR APPROVED EQUAL	PRE-BLENDED WITH AN ORGANIC STABILIZING BINDER	PATINA GRANITE COLOR BLEND	32 15 40 - STABILIZED AGGREGATE PAVING	
P-06	PAVING TYPE 06 - EWF SURFACING	4/L500	ENGINEERED WOOD FIBER, 9" DEPTH	FIBAR GROUP LLC (THE); FIBAR SYSTEM OR APPROVED EQUAL		NATURAL WOOD, BROWN		
CODE	DESCRIPTION	DETAIL	MATERIAL PROFILE/ASSEMBLY	COMMENTS				
PLAY EQUIP	MENT PLAY EQUIPMENT TYPE 01 - EXISTING GA GA BALL	N/A	RELOCATE EXISTING GA GA BALL COURT	NEW EWF SURFACE WITHIN RELOCATED				
[1-01]	COURT - RELOCATE			COURT				
CODE	DESCRIPTION	DETAIL	MATERIAL PROFILE/ASSEMBLY	MANUFACTURER	PRODUCT/MODEL	COLOR/FINISH	COMMENTS	SPEC#
SITE FURNIT	TURE	1/1 500	72IN. L, BACKED, W/ ANGLED SIDE ARMS;	LANDSCAPE FORMS OR APPROVED EQUAL	G50-TRAD-B-2AA	FRAME: MATTE BLACK LOW SHEEN, SEAT:		11 68 00 - PLAY FIELD EQUIPMENT AND STRUCTURES
SF-01	6' BACKED BENCH	1/L502	SURFACE MOUNTED	LANDSCAPE FORMS OR APPROVED EQUAL	G50-TRAD-B-ZAA	JARRAH EXTERIOR WOOD		11 68 00 - PLAY FIELD EQUIPMENT AND STRUCTURES
SF-02	6' BACKED BENCH, CENTER ARM	1/L502	72IN. L, BACKED, W/ ANGLED SIDE AND CENTER ARMS; SURFACE MOUNTED	LANDSCAPE FORMS OR APPROVED EQUAL	G50-TRAD-B-3AA	FRAME: STORMCLOUD GLOSS, SEAT: THERMALLY MODIFIED ASH EXTERIOR WOOD		11 68 00 - PLAY FIELD EQUIPMENT AND STRUCTURES
SF-03	PICNIC BENCH	2/L502	FREESTANDING PICNIC BENCH	LANDSCAPE FORMS OR APPROVED EQUAL	BAN-88, BANCAL BACKLESS BENCH 88IN, EMBEDDED, WOOD	FRAME: STEEL METALLIC, SEAT: THERMALLY MODIFIED ASH EXTERIOR WOOD		11 68 00 - PLAY FIELD EQUIPMENT AND STRUCTURES
SF-04	PICNIC TABLE	3/L502	FREESTANDING PICNIC TABLE	LANDSCAPE FORMS OR APPROVED EQUAL	BANCAL WOOD PICNIC TABLE	FRAME: STEEL METALLIC, TABLETOP: THERMALLY MODIFIED ASH EXTERIOR WOOD		11 68 00 - PLAY FIELD EQUIPMENT AND STRUCTURES
SF-05	RECEPTACLE	4/L502	GENERATION 50, LITTER RECEPTACLE, SIDE OPENING,	LANDSCAPE FORMS OR APPROVED EQUAL	GRCHN-SO OR APPROVED EQUAL	FRAME: MATTE BLACK LOW SHEEN, SLATS: JARRAH EXTERIOR WOOD		11 68 00 - PLAY FIELD EQUIPMENT AND STRUCTURES
SF-06	BIKE RACK	5/L502	BOLA BIKE RACK	LANDSCAPE FORMS OR APPROVED EQUAL	BOLA BIKE RACK OR APPROVED EQUAL	1.5" O.D., 120" WALL STAINLESS STEEL TUBING, WITH A #4		11 68 00 - PLAY FIELD EQUIPMENT AND STRUCTURES
SF-07	BENCH - LIMESTONE BLOCK BENCH	1/L501	5' LENGTH LIMESTONE BLOCK BENCH	KASOTA STONE OR APPROVED EQUAL	KASOTA PREMIUM LIMESTONE BENCH, OR APPROVED EQUAL	KASOTA PREMIUM, PREMIUM SPLIT SIDES WITH SMOOTH TOP/SEAT, OR APPROVED EQUAL	REFER TO PLAN AND DETAILS FOR BLOCK BURY DEPTH AND FUTURE IMPROVEMENTS SEAT TOP CONDITIONS	11 68 00 - PLAY FIELD EQUIPMENT AND STRUCTURES
SF-08	5' WOOD SLAT BENCH TOP - BACKLESS - TO BE INSTALLED IN FUTURE IMPROVEMENTS	1/L501	TOP OF WALL, BACKLESS, STD DEPTH, 5" LENGTH, WOOD BENCH TOP WITH JARRAH SLATS MOUNTED TO LIMESTONE BLOCK BENCH	LANDSCAPE FORMS OR APPROVED EQUAL	LINK BENCH A, STRAIGHT INLINE,	1 SECTION(S), 0 ARMREST(S), BOARD MAT'L: DSTMA W: NO FINISH, POWDER COAT COLOR: CHARCOAL		
SF-09	SURFACE MOUNT DRINKING FOUNTAIN	2/L501	SURFACE MOUNT, VANDAL-RESISTANT, ADA	MOST DEPENDABLE FOUNDTAIN OR APPROVED EQUAL	440 SMFA OR SMSSFA (FRONT APPROACH)	STAINLESS STEEL		11 68 00 - PLAY FIELD EQUIPMENT AND STRUCTURES
SF-10	EXISTING SHADE SAIL - RELOCATE	N/A	EXISTING SHADE SAIL AND POST				RELOCATE EXISTING POST AND SAIL STRUCTURE WHERE SHOWN ON PLAN	

SITE MATERIALS SCHEDULE

REFERENCE NOTES SCHEDULE PRODUCT/MODEL CODE DESCRIPTION MATERIAL PROFILE SPECIFICATION UTILITIES

U-01 IRRIGATION TYPE 01 - SPRAY / ROTATOR NOZZLE ROTOR SPRAY IRRIGATION HIGH-EFFICIENCY HEADS 32 84 00 - PLANTING IRRIGATION U-02 IRRIGATION TYPE 02 - DRIP IRRIGATION DRIP IRRIGATION HIGH-EFFICIENCY HEADS 32 84 00 - PLANTING IRRIGATION

02 SITE IRRIGATION SCHEDULE

	REFER	ENCE NOTES SCHEDULE					
	CODE	DESCRIPTION	DEPTH	COMPOSITION	NOTES	SUBGRADE PREPARATION	SPEC#
	SOIL PROFILE						
П		SOIL TYPE 01 - 6" EXISTING ON-SITE PLANTING	6"	EXISTING ON-SITE SOILS	RETAIN IN-SITU SOILS/ RE-SPREAD STOCKPILED SOILS- REMOVE EXISTING TURF/		329113 - SOIL PREPARATION
	31 -01	SOIL-NATIVE/TURF AREAS				SPECIFICATIONS	
					NATIVE SEEDING. DO NOT TILL BELOW EXISTING TREES, HAND RAKE/ LIGHT HARROW ONLY.		
		SOIL TYPE 02 - 18" EXISTING ON-SITE PLANTING	18"	EXISTING ON-SITE SOILS, AMEND TO MEET	RETAIN IN-SITU SOILS/ RE-SPREAD STOCKPILES SOILS AND AMEND IN-SITU TO A DEPTH OF 18"		329113 - SOIL PREPARATION
П	31 -02	SOILS, AMENDED - PERENNIAL AREAS		REQUIREMENTS OF LOAM TOPSOIL BORROW (MNDOT		SPECIFICATIONS	
				3877-B).	PLANTING AREAS.		
ı	SP-03	SOIL TYPE 03 - 6" IN-SITU AMENDED SOILS - AIR	6"	EXISTING, IN-SITU SOILS AMENDED WITH 1/2" COMPOST	AIR SPADE BELOW EXISTING TREES TO PREPARE SOILS FOR PERENNIAL AND GROUND	NONE.	329113 - SOIL PREPARATION
	31 -03	SPADE		TOPDRESSING	COVER PLANTING. LOOSEN SOILS TO DEPTH OF 6", TOPDRESS WITH 1/2" COMPOST BEFORE		
					PLANTING.		

O1 SITE SOILS SCHEDULE



CITY OF SAINT PETER 227 South Front Street Saint Peter, MN 56082 p: 507.934.4840

DF/ DAMON FARBER LANDSCAFE ARCHITECTS:

310 South 4th Avenue, Suite 7050 Minneapolis, MN 55415 p: 612,332,7522



BOLTON & MENK 1960 PREMIER DRIVE MANKATO, MN 56001-5900 p: 507.625.4171

NELSON-RUDIE & ASSOCIATES 9100 49TH AVE NORTH MINNEAPOLIS, MN 55428 612,669,4385

100% CONSTRUCTION DRAWINGS

GORMAN PARK ST. PETER, MINNESOTA

I hereby certify that this document was prepared by me or under my direct supervision and that I am a duly licensed Landscape Architect under the Iaws of the State of Minnesota.

Registration#

12/24/2024

100% CD SET 12/24/2024 DF/ Project # 22-150 PER SHEET Scale AG/RP/JR/JM Drawn/Checked

REVISION

SITE **MATERIALS** SCHEDULE

PLANT S	SCHE	DULE					
SYMBOL	CODE	QTY	BOTANICAL NAME	COMMON NAME	SIZE	CONT.	
CONIFEROUS T	TREES				I		
A . Ye	LL2	1	LARIX LARICINA	TAMARACK	8° HT.	B&B	
0	РВ	3	PICEA GLAUCA DENSATA	BLACK HILLS SPRUCE	8` HT.	B&B	
	PS	1	PINUS STROBUS	WHITE PINE	10` HT.	B&B	
DECIDUOUS TR	REES						
	AW	3	ACER RUBRUM 'NEW WORLD'	NEW WORLD RED MAPLE	2.5" CAL.	B&B	
	AS2	1	ACER SACCHARINUM	SILVER MAPLE	3" CAL.	B&B	
	AU2	2	ACER SACCHARUM 'JEFCAN'	UNITY® SUGAR MAPLE	2.5" CAL.	B&B	
	АМЗ	3	ACER SACCHARUM 'MORTON'	CRESCENDO™ SUGAR MAPLE	2.5" CAL.	B&B	
£ . }	со	1	CELTIS OCCIDENTALIS	COMMON HACKBERRY	2.5" CAL.	B&B	
	GI	5	GLEDITSIA TRIACANTHOS INERMIS 'SKYCOLE' TM	SKYLINE THORNLESS HONEY LOCUST	3" CAL.	B&B	
- Andrews	PD	1	POPULUS DELTOIDES 'SIOUXLAND'	EASTERN COTTONWOOD SIOUXLAND	2.5" CAL.	B&B	
No house	PT	9	POPULUS TREMULOIDES	QUAKING ASPEN	2" CAL.	B&B	
\(\frac{\partial \text{v}}{\partial \text{v}}\)	QB	6	QUERCUS BICOLOR	SWAMP WHITE OAK	2.5" CAL.	B&B	
(·)	QE	4	QUERCUS ELLIPSOIDALIS	NORTHERN PIN OAK	3" CAL.	B&B	
1 WW	QR	3	QUERCUS RUBRA	NORTHERN RED OAK	3" CAL.	B&B	
The state of the s	ТВ	1	TILIA AMERICANA 'BOULEVARD'	BOULEVARD LINDEN	2.5" CAL.	B&B	
		<u> </u>	TIENT WENTS AND	DOOLE VIII DE LINDE LI	2.0 0/12.		
ORNAMENTAL T	TREES				8` HT.		
b. d	AA	1	AMELANCHIER X GRANDIFLORA	APPLE SERVICEBERRY	MULTI-STEM	B&B	
•	CA	1	CORNUS ALTERNIFOLIA	PAGODA DOGWOOD	8` HT. MULTI-STEM	B&B	
\bigcirc	MP	2	MALUS X 'PRAIRIFIRE'	PRAIRIFIRE CRABAPPLE	2" CAL.	B&B	
SYMBOL SHRUBS	CODE	QTY	BOTANICAL NAME	COMMON NAME	SIZE	CONT.	SPAC G
(F)	АО	8	AMELANCHIER ALNIFOLIA 'OBELISK'	STANDING OVATION™ SERVICEBERRY	10 GAL	CONT.	48" o
$\overline{\bullet}$	AM	29	ARONIA MELANOCARPA `MORTON` TM	IROQUIS BEAUTY BLACK CHOKEBERRY	5 GAL	CONT.	48" c
(+)	AU	10	ARONIA MELANOCARPA `UCONNAM165` TM	LOW SCAPE MOUND CHOKEBERRY	5 GAL	CONT.	36" (
<u>(~)</u>	BA2	44	BAPTISIA ALBA	WHITE WILD INDIGO	#1	CONT.	30" 0
<u>~</u>	CSF	5	CORNUS SERICEA 'FARROW'	ARCTIC FIRE® RED TWIG DOGWOOD	5 GAL	CONT.	48" (
$\overline{\odot}$	DL	34	DIERVILLA LONICERA	DWARF BUSH HONEYSUCKLE	2 GAL	CONT.	36" c
	LIANI	19	HYDRANGEA ARBORESCENS 'ANNABELLE'	ANNABELLE HYDRANGEA	5 GAL	CONT.	60" 0
(.)	HAN	1		ODEN ONE HANDED	5 GAL	CONT	48" (
Manage of the same	JO	5	JUNIPERUS VIRGINIANA 'GREY OWL'				-
Maranest Company		5 39	JUNIPERUS VIRGINIANA 'GREY OWL' MATTEUCCIA STRUTHIOPTERIS	GREY OWL JUNIPER OSTRICH FERN	1 GAL	CONT.	30" c
A STANAS	JO			OSTRICH FERN	1 GAL	CONT.	36" (
○○○○○	JO MS	39	MATTEUCCIA STRUTHIOPTERIS	OSTRICH FERN			
$\overline{}$	JO MS PL	39 11 9	MATTEUCCIA STRUTHIOPTERIS PHYSOCARPUS OPULIFOLIUS 'LITTLE DEVIL'	OSTRICH FERN			
O O O O O O O O O O O O O O	JO MS PL	39 11 9	MATTEUCCIA STRUTHIOPTERIS PHYSOCARPUS OPULIFOLIUS 'LITTLE DEVIL'	OSTRICH FERN			
GRASSES AND	JO MS PL GRASS	39 11 9	MATTEUCCIA STRUTHIOPTERIS PHYSOCARPUS OPULIFOLIUS 'LITTLE DEVIL' EXISTING SHRUB TO REMAIN	OSTRICH FERN LITTLE DEVIL™ DWARF NINEBARK	1 GAL	CONT.	36" (
BRASSES AND	JO MS PL GRASS ARO	39 11 9 AREAS 23	MATTEUCCIA STRUTHIOPTERIS PHYSOCARPUS OPULIFOLIUS 'LITTLE DEVIL' EXISTING SHRUB TO REMAIN ANDROPOGON GERARDII 'RED OCTOBER'	OSTRICH FERN LITTLE DEVIL™ DWARF NINEBARK RED OCTOBER BIG BLUESTEM	1 GAL	CONT.	36" (

SHRUB, PEREN	INIAL, AI	ND GRASS MI	XES					GROUPINGS OF COMPATIBLE SPECIES PLANTING
		8,467 SF	UNDERSTORY PLANTING MIX 1: LOW					ORGANIZATION- GROUND COVER PLANTING INTERPLANTED WITH UNDERSTORY PLANTING MIX DRIFTS' THROUGHOUT. PART SHADE TO PART SU PLANTING. MED-DRY SOILS.
	AS4	196	ALLIUM X 'SUMMER BEAUTY'	SUMMER BEAUTY ORNAMENTAL ONION	4"	CONT	18" o.c.	
	АС3	282	ANEMONE CANADENSIS	CANADIAN ANEMONE	4"	CONT	15" o.c.	
	СРЗ	220	CAREX PENSYLVANICA	PENNSYLVANIA SEDGE	1 GAL	CONT	24" o.c.	
	DT2	440	DESCHAMPSIA CESPITOSA	TUFTED HAIR GRASS	1 GAL	CONT	24" o.c.	
	EM2	27	EURYBIA MACROPHYLLA	BIGLEAF ASTER	1 GAL	CONT	48" o.c.	
	KM2	390	KOELERIA MACRANTHA	PRAIRIE JUNEGRASS	1 GAL	CONT	18" o.c.	
	SHE	878	SPOROBOLUS HETEROLEPIS	PRAIRIE DROPSEED	1 GAL	CONT	24" o.c.	
	SO5	282	SYMPHYOTRICHUM OBLONGIFOLIUM 'OCTOBER SKIES'	OCTOBER SKIES FALL ASTER	1 GAL	CONT	15" o.c.	
		425 SF	UNDERSTORY PLANTING MIX 2: DRIFTS 24"+ HEIGHT					PERENNIAL 'DRIFTS' CONSISTING OF 2-3 COMPATIBLE PERENNIAL SPECIES IN SWEEPING MASSES (APPROX. 50-1005 FA) INTERPLANTED THROUGHOUT GROUND COVER PLANTING. PART SHADE TO PART SUN PLANTING. MED-DRY SOILS.
	LS	33	LOBELIA SPICATA	PALESPIKE LOBELIA	4"	CONT.	24" o.c.	
	CG	33	CHELONE GLABRA	WHITE TURTLE-HEAD	4"	CONT	24" o.c.	
	ML2	43	MONARDA DIDYMA 'GRAPE GUMBALL'	GRAPE GUMBALL BEE BALM	4"	CONT	24" o.c.	
		903 SF	LANDSCAPE MIX 1: LOW BROADLEAF GREEN					FORMAL ORGANIZATION WITH MASSES OF SINGLE SPECIES (IN GROUPING OF 3, 6 AND 9) AND MIXED PERENNIALS. PART SHADE TO FULL SUN. MED-DRY SOILS
	HR	90	HEUCHERA RICHARDSONII	PRAIRIE ALUM ROOT	4"	CONT.	15" o.c.	
	TE	9	TAXUS X MEDIA 'EVERLOW'	EVERLOW YEW	2 GAL	CONT.	48" o.c.	
	AC2	151	ASARUM CANADENSE	CANADIAN WILD GINGER	4"	CONT	15" o.c.	
	CS2	120	CAREX PENSYLVANICA	PENNSYLVANIA SEDGE	4"	CONT	15" o.c.	
	DTF	59	DESCHAMPSIA CESPITOSA	TUFTED HAIR GRASS	1 GAL	CONT	24" o.c.	
		1,121 SF	PERENNIAL PLANTING MIX 1: FEATURE PLANTING					PLANT PERENNIALS IN SINGLE SPECIES SWEEPING MASSES OF 9-15 PLANTS FOR LEGIBILITY. FULL SUI DRY TO MED-DRY SOILS.
	RH	58	RUDBECKIA HIRTA	BLACK-EYED SUSAN	1 GAL	CONT.	24" o.c.	
	AF	104	AGASTACHE X `BLUE FORTUNE`	BLUE FORTUNE ANISE HYSSOP	4"	CONT	18" o.c.	
	AS	43	ALLIUM STELLATUM	PRAIRIE ONION	1 GAL	CONT	24" o.c.	
	SH3	72	SPOROBOLUS HETEROLEPIS	PRAIRIE DROPSEED	1 GAL	CONT	24" o.c.	
	SP	103	SYMPHYOTRICHUM NOVAE-ANGLIAE 'PURPLE DOME'	NEW ENGLAND ASTER	4"	CONT	18" o.c.	
GROUND COVE	RS AND	GROUND CO			'	<u>'</u>		
	тн	23,318 SF	TURF HYDROSEED	DROUGHT TOLERANT FESCUE BLEND	SEED	SEED		DROUGHT TOLERANT KENTUCKY BLUE/ FESCUE BLEND. SEE SPECIFICATIONS FOR SEED MIX
* * * * * *		12,884 SF	MEADOW SEED MIX					COMPOSITION NATIVE SEEDING WITH PERENNIAL PLUGS ENHANCEMENTS. PLUGS TO BE PLANTED IN MIXEL SPECIES MASSES (50-100SF) AT SELECT LOCATION THROUGHOUT (25% OF PLANTING AREA). PART SHADE TO PART SUN, DRY TO MED-DRY SOILS.
	SM	192	NATIVE SEED MIX TYPE 1		SEED	SEED		BWSR URBAN PRAIRIE SEED MIX, MODIFIED FOR SHADE. SEED AT 12 LBS/ ACRE* - SEE SPECIFICATIONS FOR MIX COMPOSITION *SEED AT INCREASED SEEDING RATE TO SUPPORT SEED BANK CREATION. PROVIDE COVER CROP: SPRING SEEDING: OATS AT 25 LBS/A-FALL SEEDING (AUG 1 - OCT 15): WINTER WHEAT A 25 LBS/
	АТ	33	ASCLEPIAS TUBEROSA	BUTTERFLY MILKWEED	PLUG	PLUG	24" o.c.	
	ВА	33	BAPTISIA ALBA	WHITE WILD INDIGO	PLUG	PLUG	24" o.c.	
	СР	33	CAREX PENSYLVANICA	PENNSYLVANIA SEDGE	PLUG	PLUG	24" o.c.	
	DP2	33	DALEA PURPUREA	PURPLE PRAIRIE CLOVER	PLUG	PLUG	24" o.c.	
	EP	33	ECHINACEA PALLIDA	PALE PURPLE CONEFLOWER	1 GAL	CONT.	24" o.c.	
	GM3	33	GERANIUM MACULATUM	SPOTTED GERANIUM	PLUG	PLUG	24" o.c.	
	LA2	33	LIATRIS ASPERA	ROUGH BLAZING STAR	PLUG	PLUG	24" o.c.	
	i		I .	T. Control of the Con	1	1	1	I .



DF/ DAMON FARBER LANDSCAPE ARCHITECTS

310 South 4th Avenue, Suite 7050 Minneapolis, MN 55415 p: 612,332,7522



BOLTON & MENK 1960 PREMIER DRIVE MANKATO, MN 56001-5900 p: 507.625.4171

NELSON-RUDIE
NELSON-RUDIE & ASSOCIATES
9100 49TH AVE NORTH
MINNEAPOLIS, MN 55428
612,669,4385

100% CONSTRUCTION DRAWINGS

GORMAN PARK

ST. PETER, MINNESOTA

I hereby certify that this document was prepared by me or under my direct supervision and that I am a duly licensed Landscape Architect under the laws of the State of Minnesota.

Registration# 26292

 100% CD SET
 12/24/2024


 DF/ Project #
 22-150

 Scale
 PER SHEET

 Drawn/Checked
 AG / RP / JR / JM

REVISION

SITE PLANTING SCHEDULE

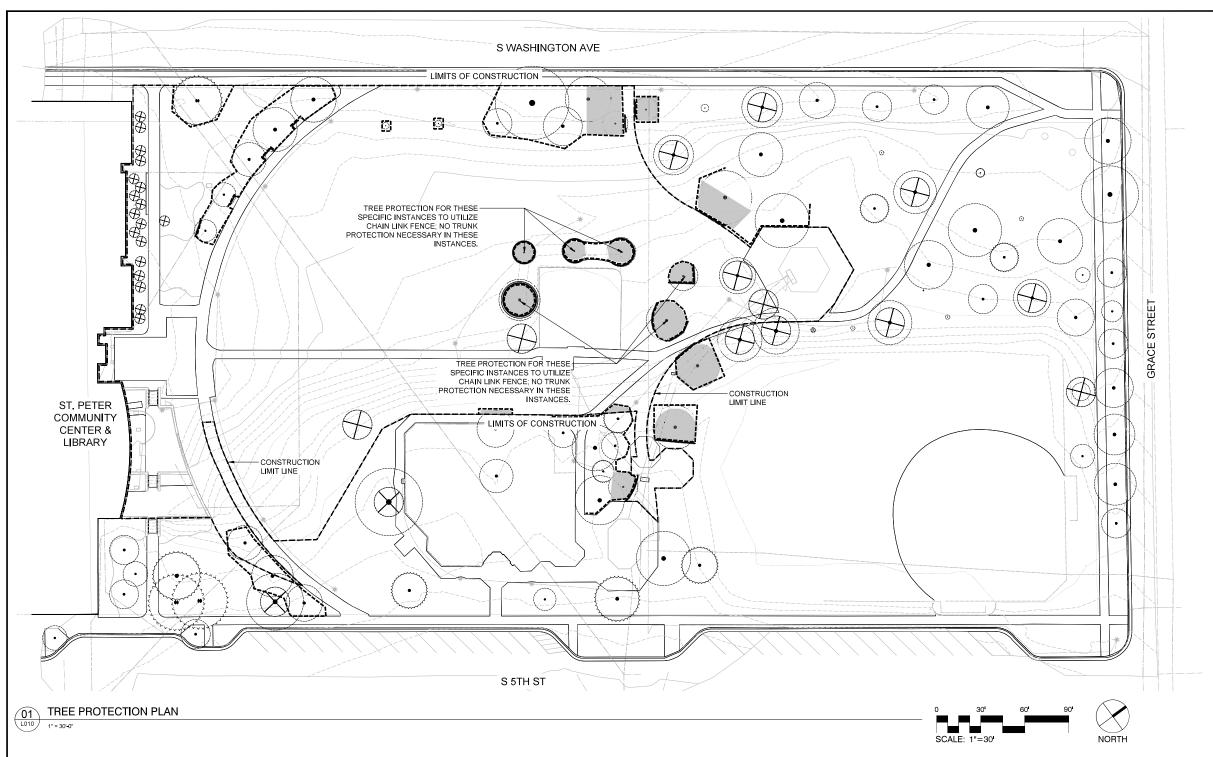

LEGEND: TREE PROTECTION PLAN



EXISTING TREE / SHRUB TO BE REMOVED, CLEAR AND GRUB STUMP/ROOTS

EXISTING TREE TO REMAIN

TREE PROTECTION FENCE
ROOT PRUNE

ROOT PROTECTION ZONE

-HAND EXCAVATION ONLY -PROVIDE 4" LAYER PROTECTIVE MULCH

TREE PRESERVATION NOTES

SITE SPECIFIC NOTES

- ALL ASH TREES TO BE REMOVED FROM SITE. TREES TO BE CLEARED AND GRUBBED. STUMPS TO BE GROUND AT LEAST 18" BELOW GRADE.
- 2. IF CONSTRUCTION NECESSITATES ACCESS OR ADDITIONAL WORK BELOW DRIPLINES OF EXISTING TREES AND PROTECTION ZONES, CONTRACTOR SHALL OBTAIN PRIOR APPROVAL BY LANDSCAPE ARCHITECT AND PROVIDE TREE PROTECTION PLAN. INDICATE LOCATIONS AND TYPES OF PROTECTION MEASURES INCLUDING TRACK PADS, AND PERIOD OF DISTURBANCE.
- 3. CONTRACTOR TO COORDINATE SHRUB REMOVAL WITH LANDSCAPE ARCHITECT. SITE TO BE WALKED PRIOR TO DEMO AND REMOVAL TO ENSURE ALL SHRUBS FOR REMOVAL ARE LOCATED.

TREE PROTECTION

- CONTRACTOR SHALL PRESERVE TREES SHOWN IN THE DRAWINGS TO BE PROTECTED AND PRESERVED, INSTALL TREE PROTECTION MEASURES PER DETAILS.
- TREE PROTECTION MEASURES ARE TO BE INSTALLED PRIOR TO
 DEMOLITION AND SHALL BE MAINTAINED FOR THE DURATION OF THE
 CONSTRUCTION PERIOD.
- 5. NO WORK SHALL OCCUR IN TREE PROTECTION ZONES.

- 6. CONTRACTOR SHALL TAKE EXTRA PRECAUTIONS TO MINIMIZE DAMAGE TO TREES WHERE WORK IS DESIGNATED TO OCCUR WITHIN AND ADJACENT TO THE DRIPLINE OF TREES. REFER TO TREE PROTECTION DETAILS FOR TREE PROTECTION FENCE, TRUNK PROTECTION, AND PRUNING PRACTICES.
- 6.1. EXCAVATION WORK WITHIN DRIPLINE OF TREES SHALL BE LIMITED TO HAND REMOVAL, DIRECTIONAL BORING, AND AIR KNIFE ONLY TO MINIMIZE DAMAGE TO ROOT SYSTEMS. SEE SPECIFICATIONS FOR DIRECTIONAL BORING DEPTHS WITHIN DRIPLINE OF TREES.
- 6.2. WHERE WORK IS TO OCCUR WITHIN DRIPLINE OF TREES, PROVIDE ROOT PRUNING AS CLEANLY CUT ROOTS PRIOR TO EXCAVATION OR TRENCHING ACTIVITIES. ROOT PRUNING TO BE PERFORMED BY ISA CERTIFIED ARBORIST FAMILIAR WITH ROOT PRUNING PRACTICES.
- 6.3. PROTECT TRUNK AND BRANCHES FROM DAMAGE WHERE WORK IS DESIGNATED TO OCCUR WITHIN THE DRIPLINE OF TREES. PROVIDE TRUNK PROTECTION PER DETAILS.
- CONTRACTOR SHALL NOT PLACE TEMPORARY STRUCTURES OR STORE MATERIALS IN TREE PROTECTION ZONES OR WITHIN THE DRIPLINE OF TREES.

ROOT PROTECTION

- IN AREAS WHERE WORK OCCURS WITHIN DRIPLINE OF TREES AND IDENTIFIED AS ROOT PROTECTION ZONES, CONTRACTOR SHALL USE EXTRA PRECAUTION TO MINIMIZE DISTURBANCE TO ROOTS DEPOS OF THE PROPERTY OF THE PROPERTY
- 2. PROVIDE PROTECTIVE 4" ORGANIC WOOD MULCH LAYER IN ROOT PROTECTION ZONES AS INDICATED ON PLAN OR WHERE WORK OCCURS WITHIN DRIPLINE. PROVIDE CLEAN ROOT CUTTING, AND LOW-IMPACT EXCAVATION MEASURES WHERE WORK IS TO OCCUR IN ROOT PROTECTION ZONES.
- CONTRACTOR SHALL NOT STORE MATERIALS, EQUIPMENT, OR PARK VEHICLES IN ROOT PROTECTION ZONES.



CITY OF SAINT PETER 227 South Front Street Saint Peter, MN 56082 p: 507.934.4840

DF/

DAMON FARBER LANDSCAPE ARCHITECTS

310 South 4th Avenue, Suite 7050 Minneapolis, MN 55415 p: 612,332,7522



BOLTON & MENK 1960 PREMIER DRIVE MANKATO, MN 56001-5900 p: 507.625.4171

NELSON-RUDIE & ASSOCIATES

9100 49TH AVE NORTH MINNEAPOLIS, MN 55428 612,669,4385

> 100% CONSTRUCTION DRAWINGS


GORMAN PARK

ST. PETER, MINNESOTA

I hereby certify that this document was prepared by me or under my direct supervision and that I am a duly licensed Landscape Architect under the laws of the State of Minnesota.

	2020
Ton Others	12/24/202
Signature	Dat
100% CD SET	12/24/202
DF/ Project #	22-15
Scale	PER SHEE
Drawn/Checked	AG / RP / JR / Jf
REVISION	

TREE PROTECTION PLAN

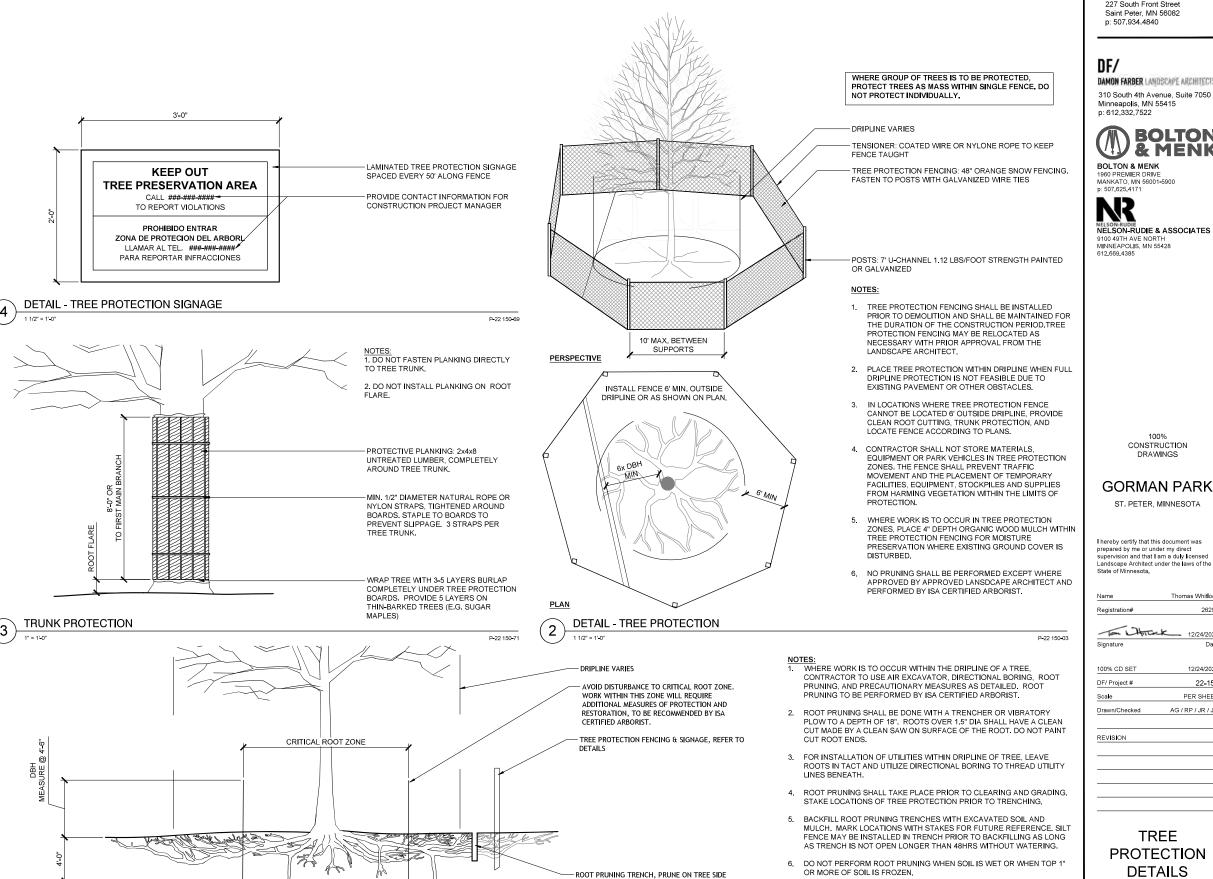

OF PROTECTION FENCE, 6" WIDE MAX x 18" TYP

ROOT PRUNING & DIRECTIONAL BORING DETAIL

DIRECTIONAL BORING PERMITTED AT MIN 4' DEPTH UNDER

CROWN DRIPLINE OF TREES. OPEN TRENCHING PERMITTED

CITY OF **SAINT** PETER

CITY OF SAINT PETER 227 South Front Street Saint Peter, MN 56082 p: 507.934.4840

DAMON FARBER LANDSCAPE ARCHITECTS

310 South 4th Avenue, Suite 7050



NELSON-RUDIE & ASSOCIATES

GORMAN PARK

ST. PETER, MINNESOTA

I hereby certify that this document was

12/24/2024 22-150 PER SHEET AG / RP / JR / JN

PROTECTION


P-22 150-62

7. AVOID DISTURBANCE WITHIN CRITICAL ROOT ZONE. CRITICAL ROOT ZONE SHALL BE MEASURED FROM TRUNK OUTWARD AND CALCULATED

DBH > 30" USE 1.5 FOOT RADIUS PER 1 INCH DBH

DBH < 29.9" USE 1 FOOT RADIUS PER 1 INCH DBH, MIN 3' RADIUS

AS FOLLOWS:

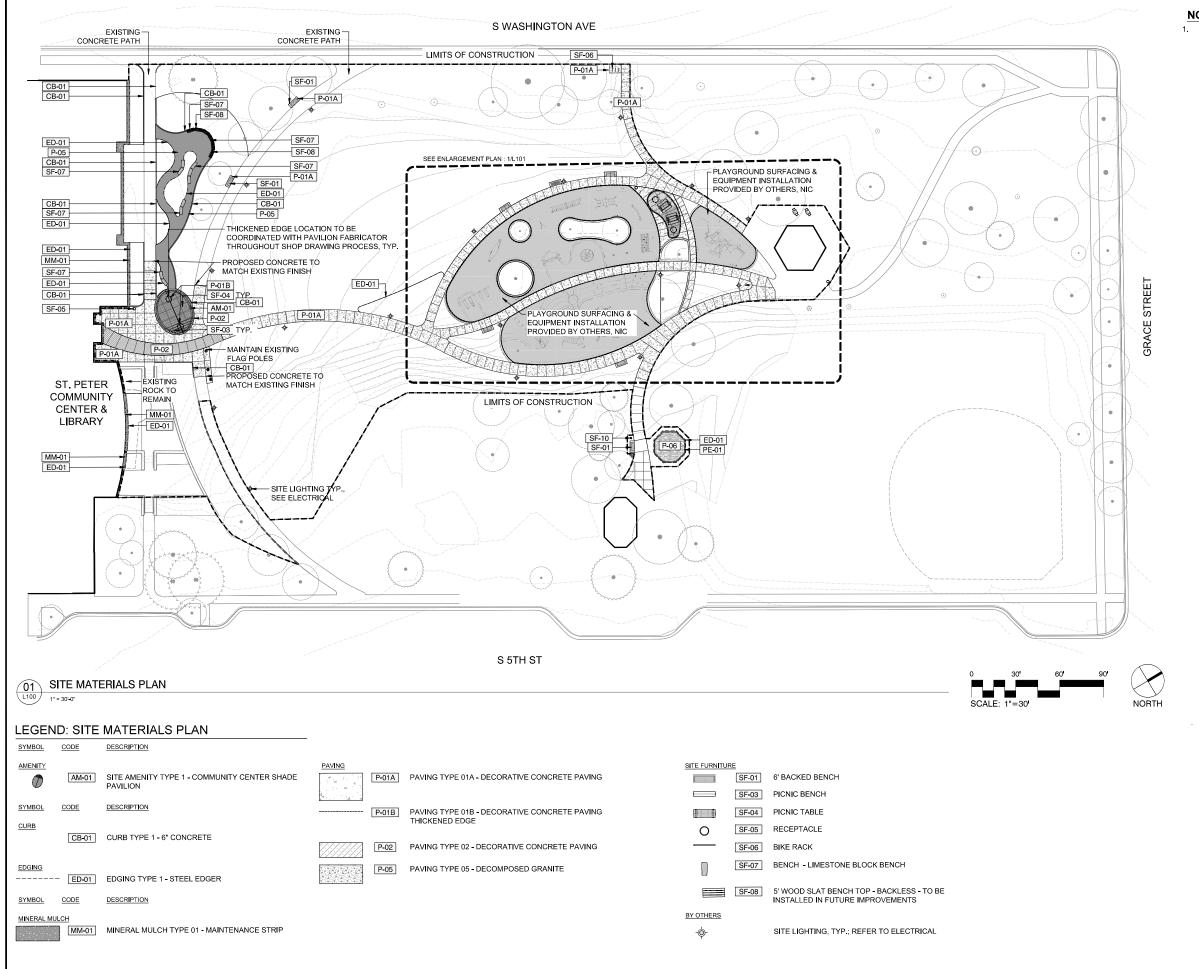

NOTES

 CITY OF SAINT PETER IS IN DIRECT CONTRACT WITH PLAY MANUFACTURER. CONTRACTOR IS RESPONSIBLE FOR ALL COORDINATION EFFORTS WITH PLAY MANUFACTURER TO ENSURE SITE PREPARATION IS COMPLETE AND ON SCHEDULE FOR INSTALLATION OF SURFACE AND EQUIPMENT.



CITY OF SAINT PETER 227 South Front Street Saint Peter, MN 56082 p: 507.934.4840

DF/

DAMON FARBER LANDSCAPE ARCHITECTS

310 South 4th Avenue, Suite 7050 Minneapolis, MN 55415 p: 612,332,7522



BOLTON & MENK 1960 PREMIER DRIVE MANKATO, MN 56001-5900 p: 507.625.4171

NELSON-RUDIE & ASSOCIATES

9100 49TH AVE NORTH MINNEAPOLIS, MN 55428 612,669,4385

> 100% CONSTRUCTION DRAWINGS


GORMAN PARK

ST. PETER, MINNESOTA

I hereby certify that this document was prepared by me or under my direct supervision and that I am a duly licensed Landscape Architect under the laws of the State of Minnesota.

Jan White	12/24/20
Signature	Da
100% CD SET	12/24/20
DF/ Project #	22-1
Scale	PER SHEE
Drawn/Checked	AG/RP/JR/
REVISION	

SITE MATERIALS PLAN

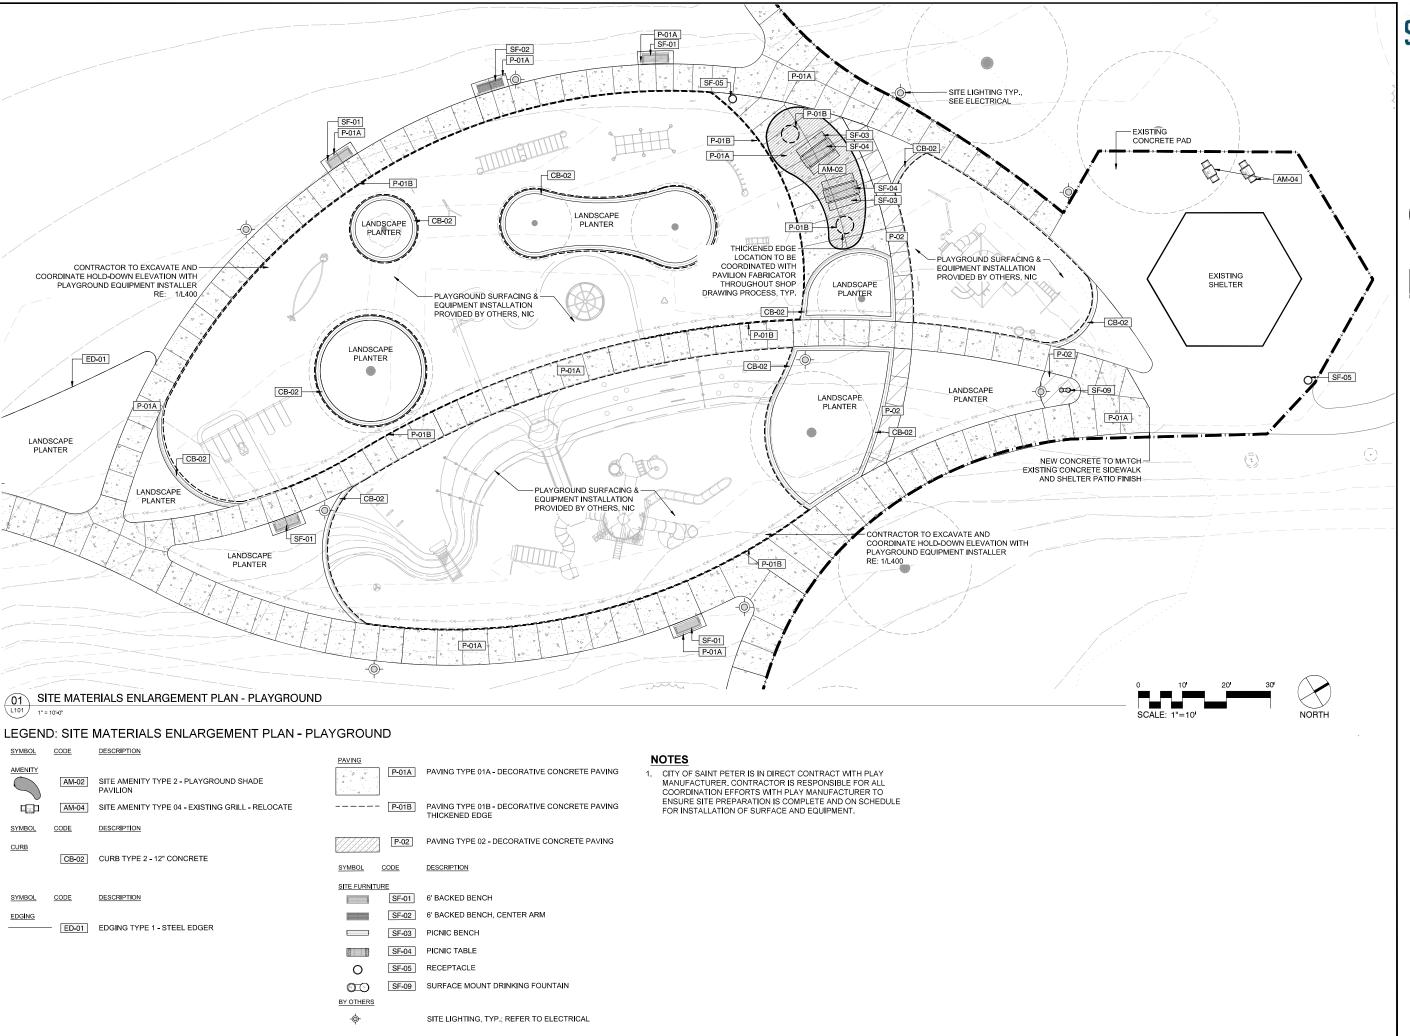



DF/

DAMON FARBER LANDSCAPE ARCHITECTS

310 South 4th Avenue, Suite 7050 Minneapolis, MN 55415 p: 612.332.7522



BOLTON & MENK 1960 PREMIER DRIVE MANKATO, MN 56001-5900 p: 507.625.4171

ELSON-RUDIE

NELSON-RUDIE & ASSOCIATES
NELSON-RUDIE & ASSOCIATES
9100 49TH AVE NORTH
MINNEAPOLIS, MN 55428
612.669.4385

100% CONSTRUCTION DRAWINGS


GORMAN PARK

ST. PETER, MINNESOTA

I hereby certify that this document was prepared by me or under my direct supervision and that I am a duly licensed Landscape Architect under the laws of the State of Minnesota.

Signature	Da
100% CD SET	12/24/202
DF/ Project #	22-15
Scale	PER SHEE
Drawn/Checked	AG/RP/JR/J

SITE MATERIALS ENLARGEMENT PLAN -PLAYGROUND

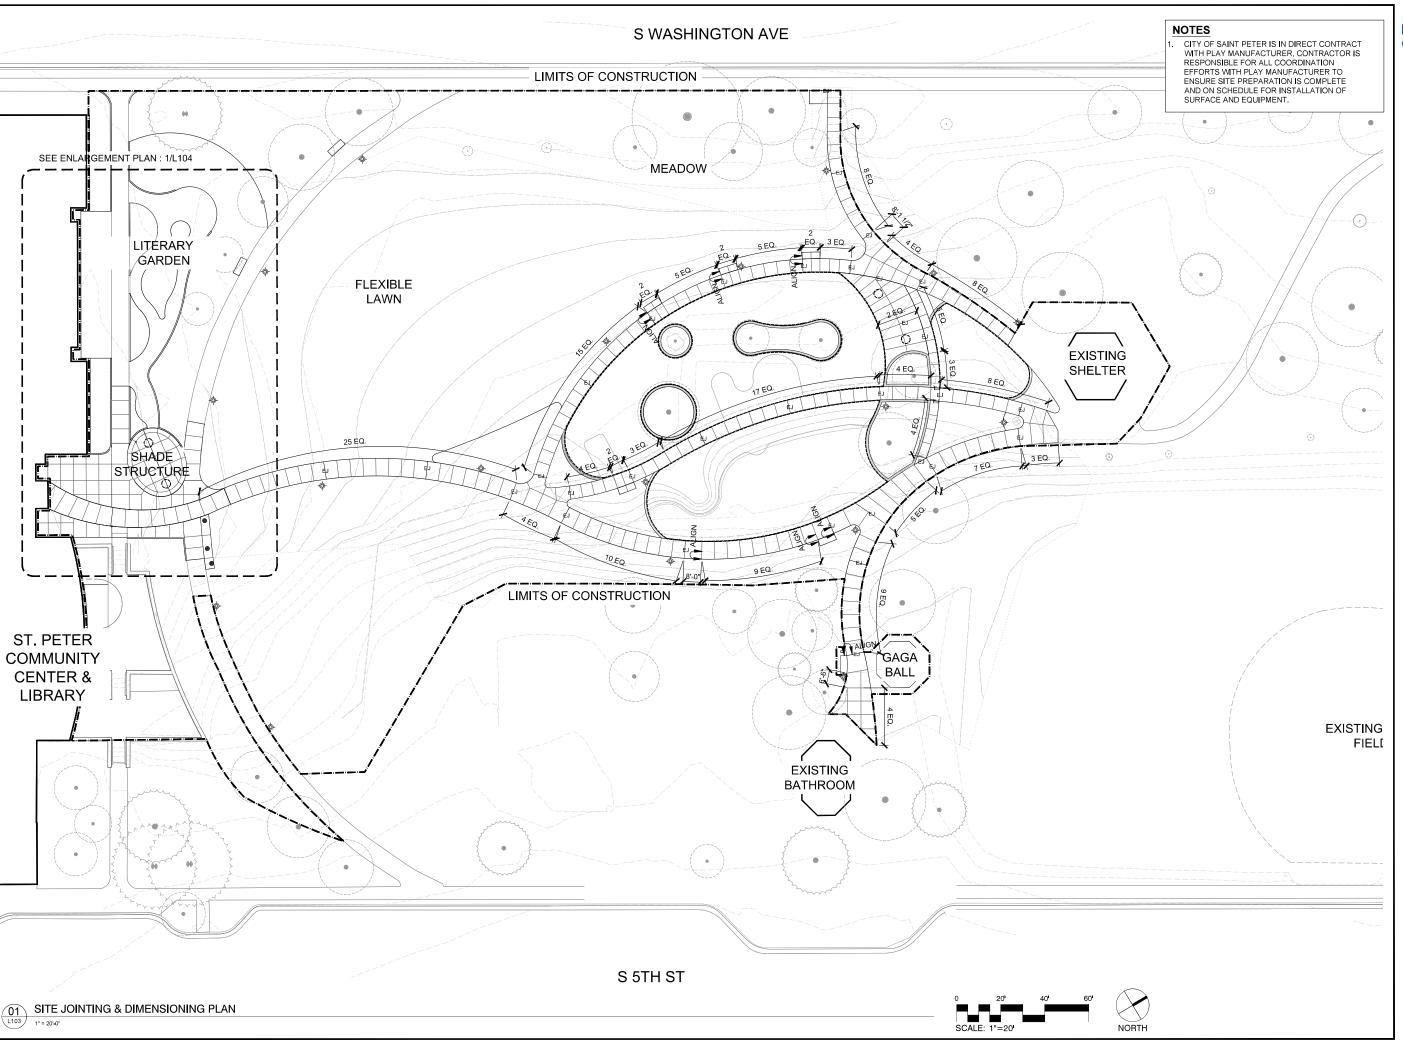



UF/

DAMON FARBER LANDSCAPE ARCHITECTS:

310 South 4th Avenue, Suite 7050 Minneapolis, MN 55415 p: 612,332,7522



BOLTON & MENK 1960 PREMIER DRIVE MANKATO, MN 56001-5900 p: 507.625.4171

ELSON-RUDIE

NELSON-RUDIE & ASSOCIATES 9100 49TH AVE NORTH MINNEAPOLIS, MN 55428 612.669.4385

> 100% CONSTRUCTION DRAWINGS

GORMAN PARK

ST. PETER, MINNESOTA

I hereby certify that this document was prepared by me or under my direct supervision and that I am a duly licensed Landscape Architect under the laws of the State of Minnesota.

Registration# 26292

To Throck 12/24/2024

Signature Date

 100% CD SET
 12/24/2024


 DF/ Project #
 22-150

 Scale
 PER SHEET

 Drawn/Checked
 AG / RP / JR / JM

REVISION

SITE JOINTING & DIMENSIONING PLAN

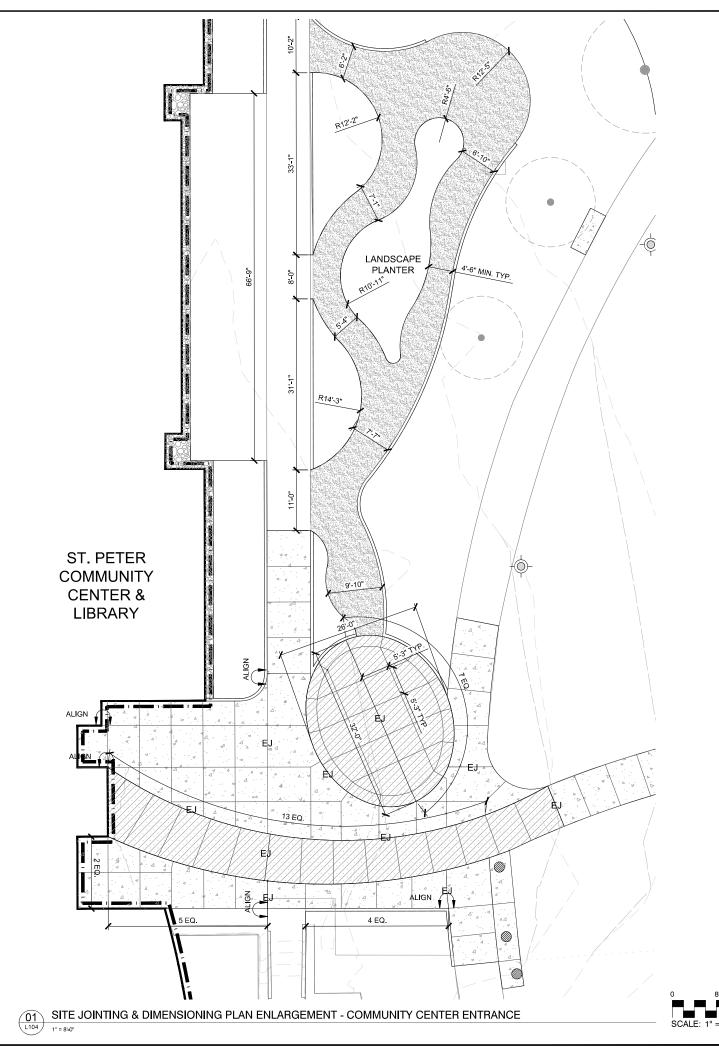



DAMON FARBER LANDSCAFE ARCHITECTS

310 South 4th Avenue, Suite 7050 Minneapolis, MN 55415 p: 612,332,7522



BOLTON & MENK 1960 PREMIER DRIVE MANKATO, MN 56001-5900 p: 507.625.4171

NELSON-RUDIE NELSON-RUDIE & ASSOCIATES 9100 49TH AVE NORTH MINNEAPOLIS, MN 55428 612,669,4385

100% CONSTRUCTION DRAWINGS

GORMAN PARK

ST. PETER, MINNESOTA


I hereby certify that this document was prepared by me or under my direct supervision and that I am a duly licensed Landscape Architect under the laws of the State of Minnesota.

Registration#

12/24/2024 22-150 DF/ Project # PER SHEET AG/RP/JR/JM Drawn/Checked

REVISION

SITE JOINTING & **DIMENSIONING** PLAN **ELARGEMENTS**

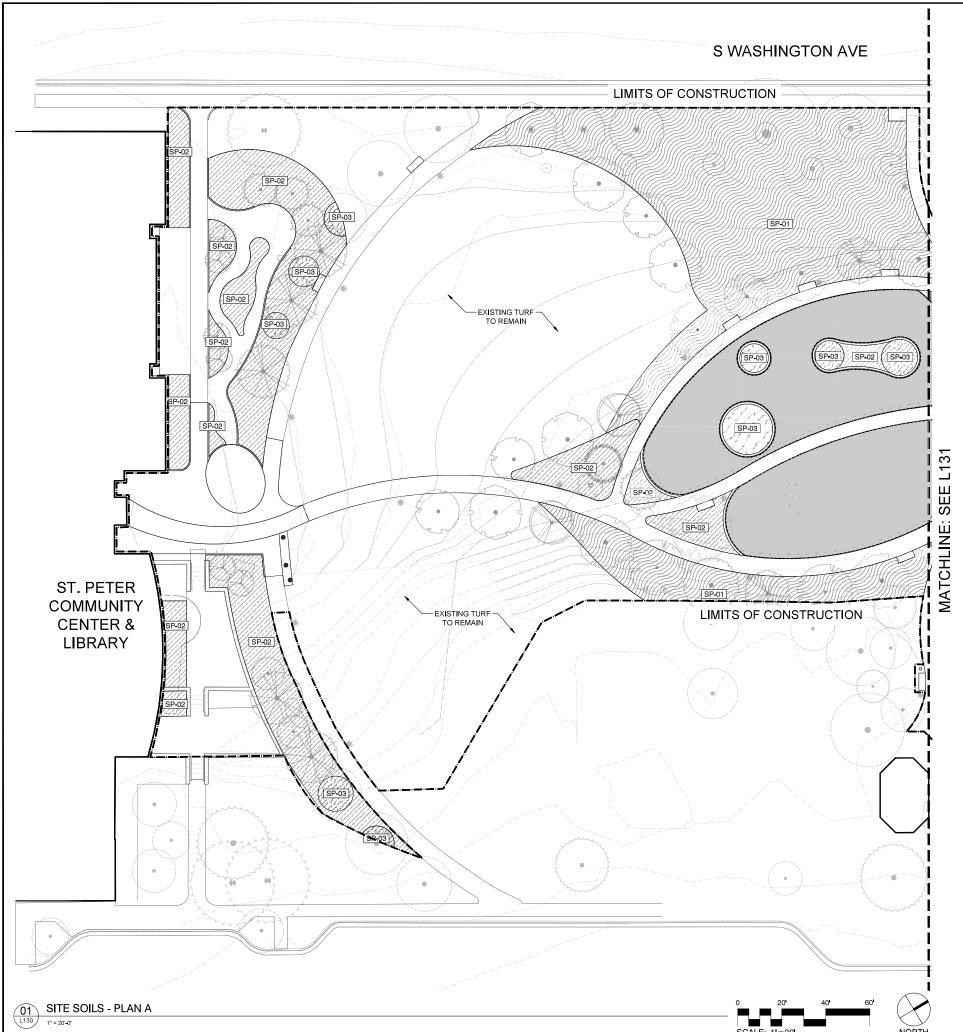

LEGEND: SITE SOILS - PLAN A

SYMBOL DESCRIPTION SOIL PROFILE SOIL TYPE 01 - 6" EXISTING ON-SITE PLANTING SOIL-NATIVE/TURF AREAS SP-02 SOIL TYPE 02 - 18" EXISTING ON-SITE PLANTING SOILS, AMENDED - PERENNIAL AREAS SOIL TYPE 03 - 6" IN-SITU AMENDED SOILS - AIR

NOTE:

1. WHERE USING IN-SITU SOILS AS PLANTING SOILS, RETAIN IN PLACE AND PROTECT EXISTING SOILS FROM COMPACTION AND CONSTRUCTION ACTIVITIES.



CITY OF SAINT PETER 227 South Front Street Saint Peter, MN 56082 p: 507.934.4840

DAMON FARBER LANDSCAPE ARCHITECTS

310 South 4th Avenue, Suite 7050 Minneapolis, MN 55415 p: 612,332,7522



BOLTON & MENK 1960 PREMIER DRIVE MANKATO, MN 56001-5900 p: 507.625.4171

NELSON-RUDIE NELSON-RUDIE & ASSOCIATES

9100 49TH AVE NORTH MINNEAPOLIS, MN 55428 612,669,4385

100% CONSTRUCTION DRAWINGS

GORMAN PARK

ST. PETER, MINNESOTA


I hereby certify that this document was prepared by me or under my direct supervision and that I am a duly licensed Landscape Architect under the laws of the State of Minnesota.

100% CD SET 12/24/2024 DF/ Project # 22-150 PER SHEET AG/RP/JR/JM

Registration#

REVISION

SITE SOILS -PLAN A

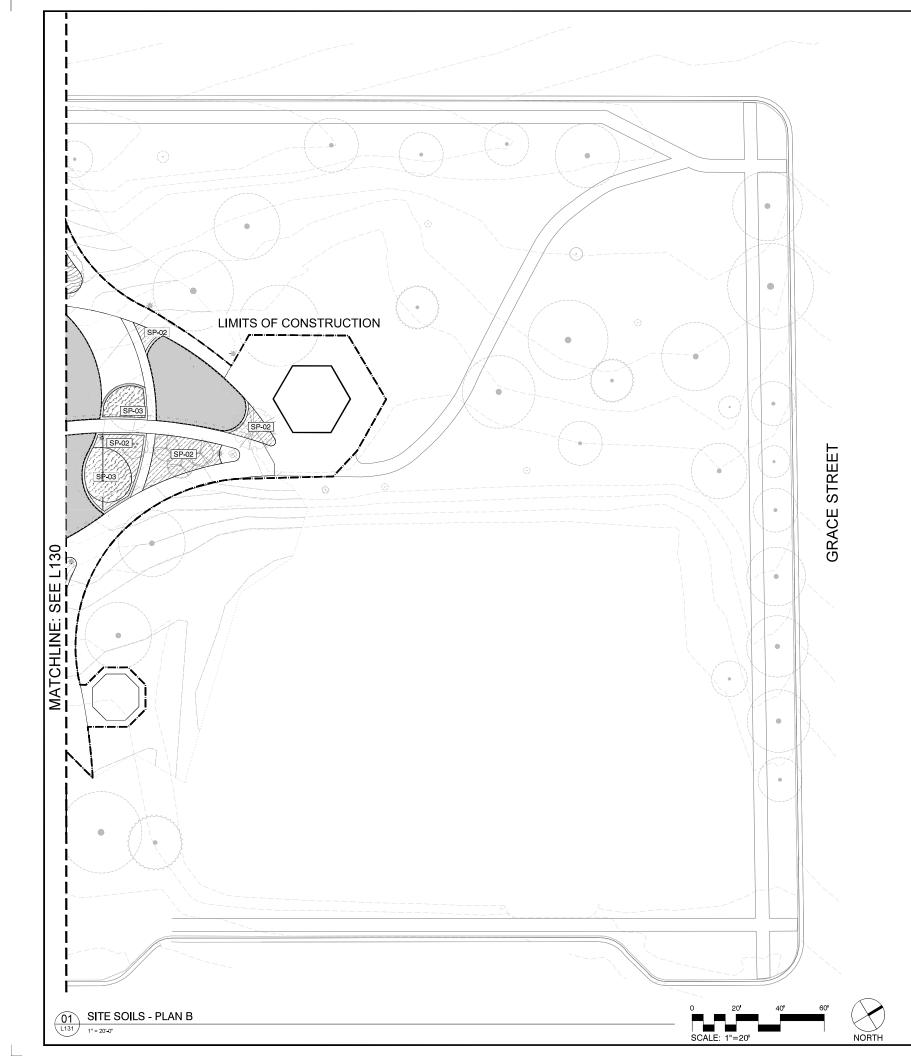

LEGEND: SITE SOILS - PLAN B

SYMBOL DESCRIPTION SOIL PROFILE SP-01 SOIL TYPE 01 - 6" EXISTING ON-SITE PLANTING SOIL-NATIVE/TURF AREAS SP-02 SOIL TYPE 02 - 18" EXISTING ON-SITE PLANTING SOILS, AMENDED - PERENNIAL AREAS SP-03 SOIL TYPE 03 - 6" IN-SITU AMENDED SOILS - AIR SPADE

NOTE:

1. WHERE USING IN-SITU SOILS AS PLANTING SOILS, RETAIN IN PLACE AND PROTECT EXISTING SOILS FROM COMPACTION AND CONSTRUCTION ACTIVITIES.



CITY OF SAINT PETER 227 South Front Street Saint Peter, MN 56082 p: 507.934.4840

DAMON FARBER LANDSCAPE ARCHITECTS

310 South 4th Avenue, Suite 7050 Minneapolis, MN 55415 p: 612,332,7522



BOLTON & MENK 1960 PREMIER DRIVE MANKATO, MN 56001-5900 p: 507.625.4171

NELSON-RUDIE NELSON-RUDIE & ASSOCIATES 9100 49TH AVE NORTH MINNEAPOLIS, MN 55428 612,669,4385

100% CONSTRUCTION DRAWINGS

GORMAN PARK

ST. PETER, MINNESOTA


I hereby certify that this document was prepared by me or under my direct supervision and that I am a duly licensed Landscape Architect under the laws of the State of Minnesota.

12/24/2024 100% CD SET 12/24/2024 DF/ Project # 22-150 PER SHEET Scale AG/RP/JR/JM Drawn/Checked


Registration#

REVISION

SITE SOILS -PLAN B

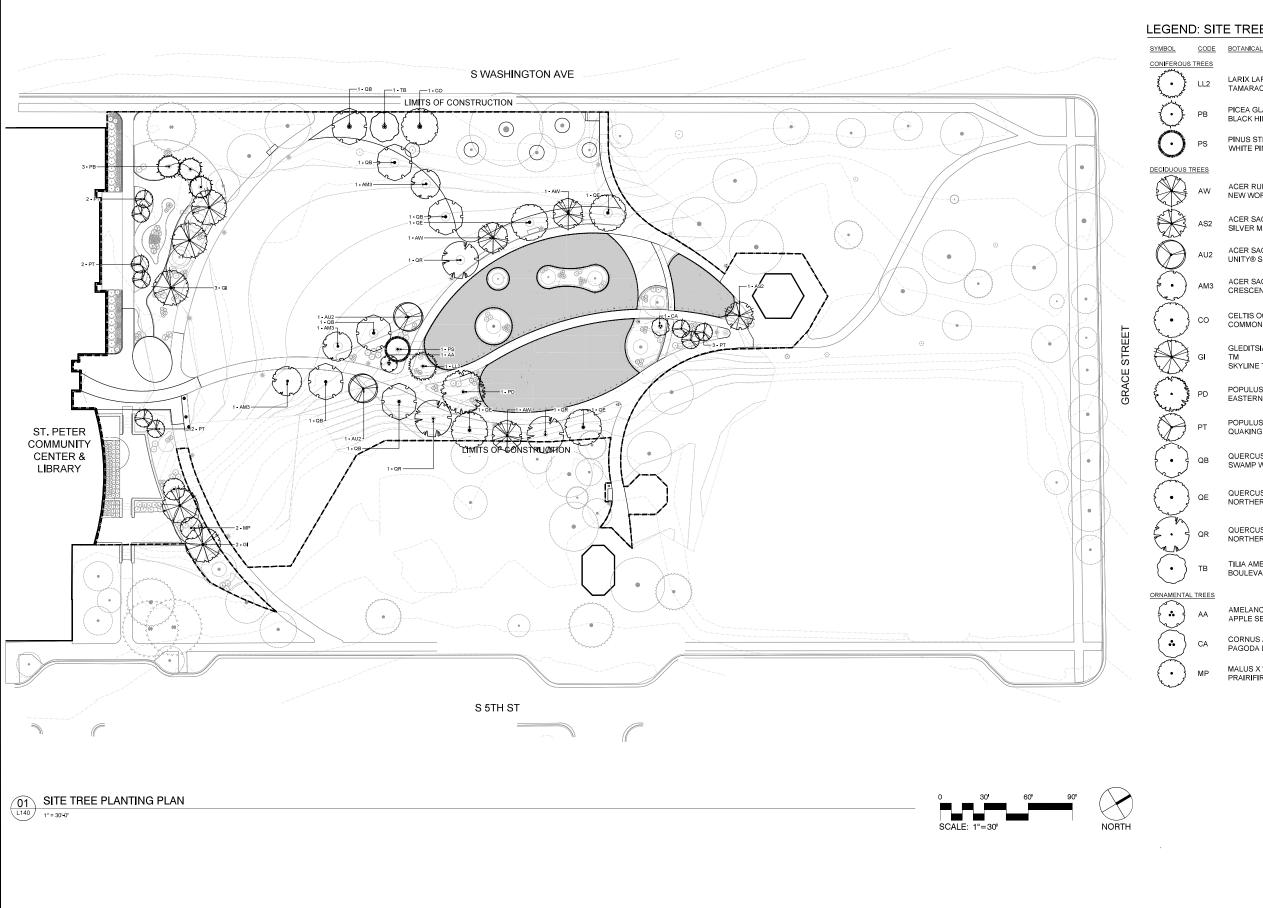

LEGEND: SITE TREE PLANTING PLAN

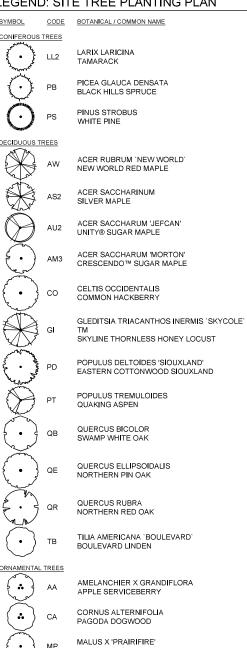



CITY OF SAINT PETER 227 South Front Street Saint Peter, MN 56082 p: 507.934.4840

DAMON FARBER LANDSCAPE ARCHITECTS

310 South 4th Avenue, Suite 7050 Minneapolis, MN 55415 p: 612.332.7522



BOLTON & MENK 1960 PREMIER DRIVE MANKATO, MN 56001-5900 p: 507.625.4171

NELSON-RUDIE & ASSOCIATES 9100 49TH AVE NORTH MINNEAPOLIS, MN 55428 612,669,4385

> 100% CONSTRUCTION DRAWINGS

GORMAN PARK

ST. PETER, MINNESOTA

I hereby certify that this document was prepared by me or under my direct supervision and that I am a duly licensed Landscape Architect under the laws of the State of Minnesota.


Registration#

12/24/2024

100% CD SET 12/24/2024 DF/ Project # 22-150 PER SHEET AG / RP / JR / JM Drawn/Checked

REVISION

SITE TREE **PLANTING** PLAN

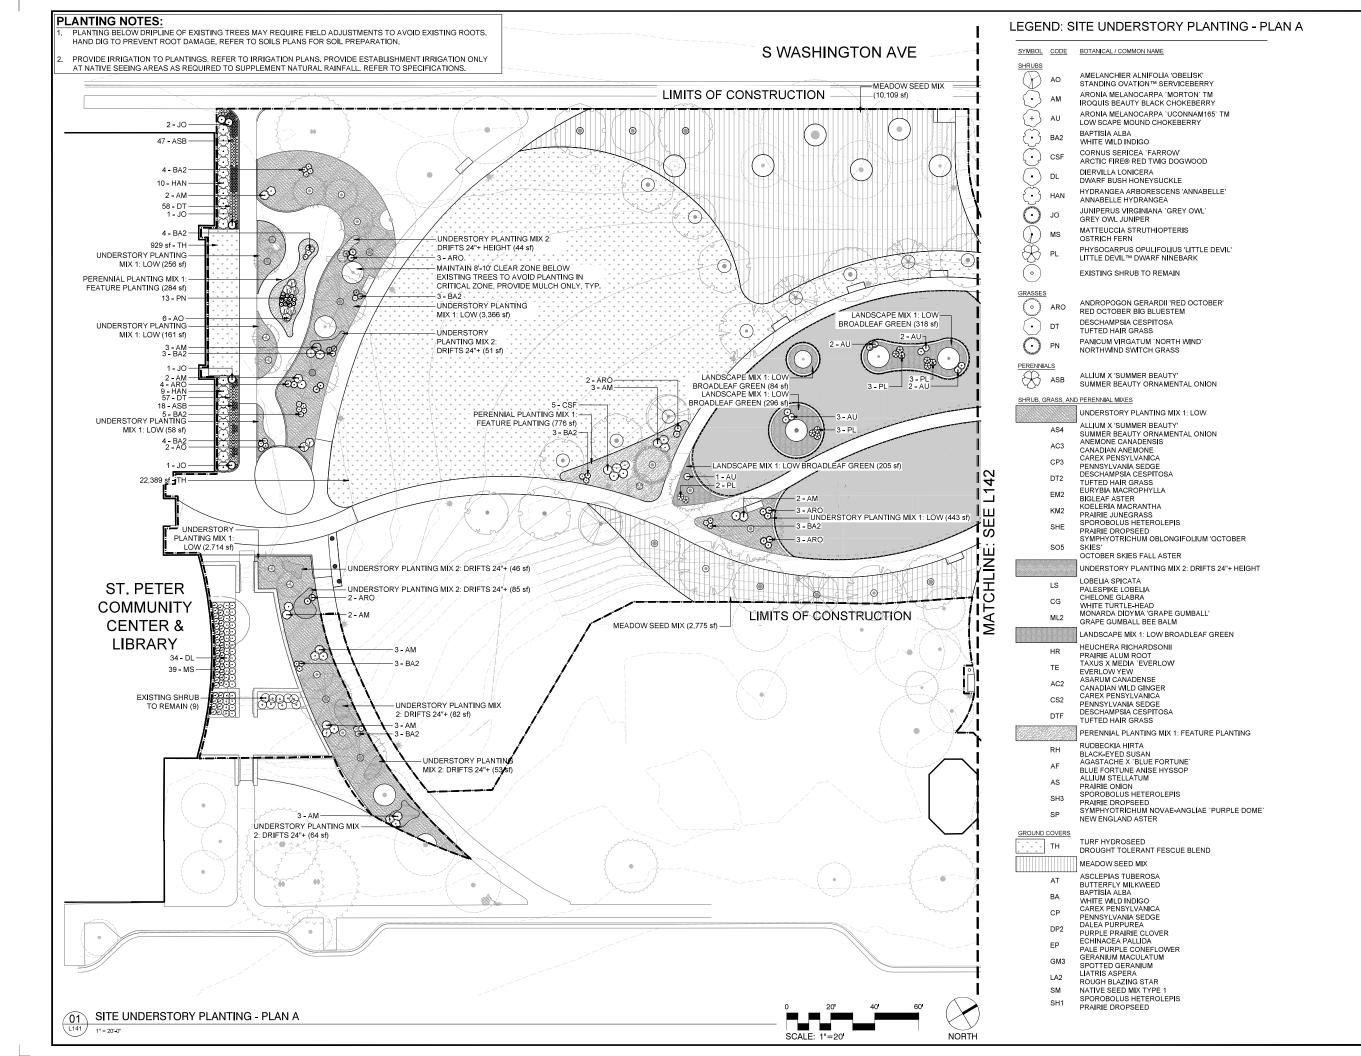



DF/

DAMON FARBER LANDSCAPE ARCHITECTS

310 South 4th Avenue, Suite 7050 Minneapolis, MN 55415 p; 612.332.7522



BOLTON & MENK 1960 PREMIER DRIVE MANKATO, MN 56001-5900 p: 507.625.4171

p: 507.625.4171

NELSON-RUDIE & ASSOCIATES 9100 49TH AVE NORTH MINNEAPOLIS, MN 55428 612,669,4385


> 100% CONSTRUCTION DRAWINGS

GORMAN PARK

ST. PETER, MINNESOTA

I hereby certify that this document was prepared by me or under my direct supervision and that I am a duly licensed Landscape Architect under the laws of the State of Minnesota,

> SITE UNDERSTORY PLANTING -PLAN A

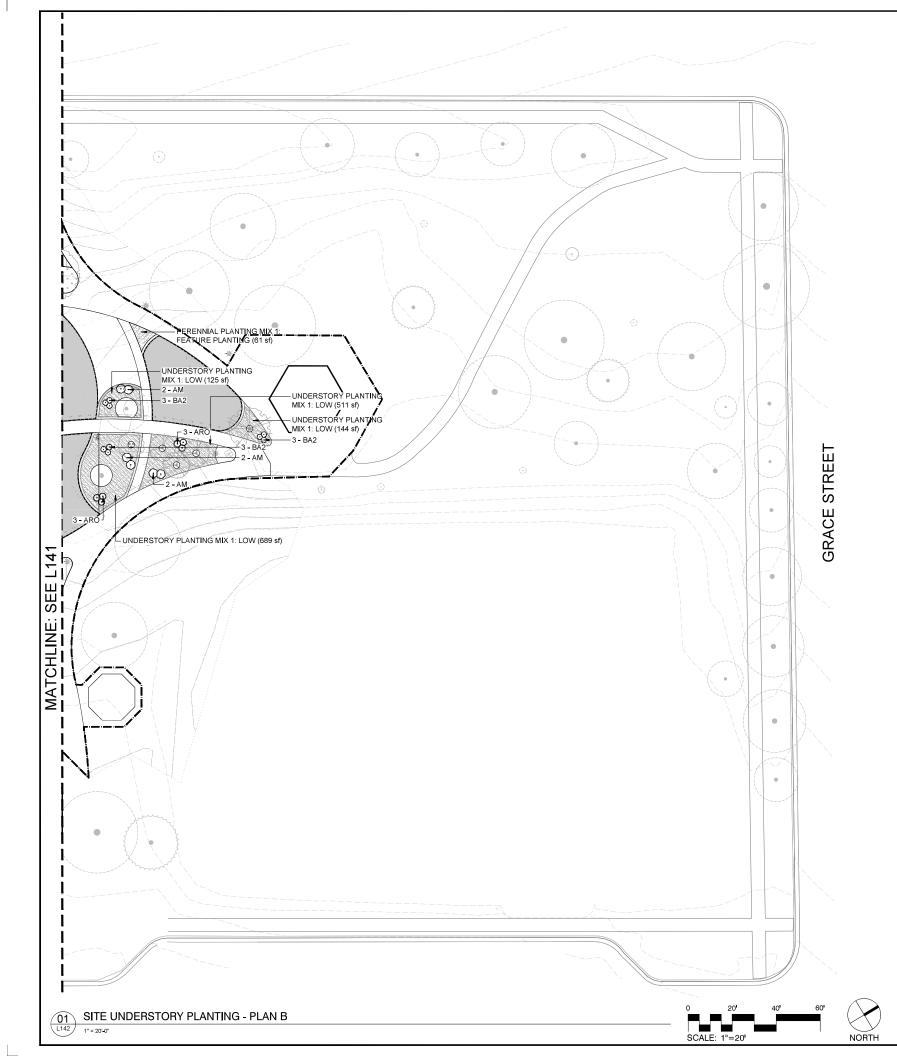



- PLANTING BELOW DRIPLINE OF EXISTING TREES MAY REQUIRE FIELD ADJUSTMENTS TO AVOID EXISTING ROOTS. HAND DIG TO PREVENT ROOT DAMAGE. REFER TO SOILS PLANS FOR SOIL PREPARATION.
- 2. PROVIDE IRRIGATION TO PLANTINGS, REFER TO IRRIGATION PLANS. PROVIDE ESTABLISHMENT IRRIGATION ONLY AT NATIVE SEEING AREAS AS REQUIRED TO SUPPLEMENT NATURAL RAINFALL. REFER TO SPECIFICATIONS.

LEGEND: SITE UNDERSTORY PLANTING - PLAN B

SYMBOL CODE BOTANICAL / COMMON NAME SHRUBS ARONIA MELANOCARPA 'MORTON' TM AM IROQUIS BEAUTY BLACK CHOKEBERRY BAPTISIA ALBA ANDROPOGON GERARDII 'RED OCTOBER' (ARO RED OCTOBER BIG BLUESTEM SHRUB, GRASS, AND PERENNIAL MIXES UNDERSTORY PLANTING MIX 1: LOW ALLIUM X 'SUMMER BEAUTY' SUMMER BEAUTY ORNAMENTAL ONION ANEMONE CANADENSIS AC3 CANADIAN ANEMONE CAREX PENSYLVANICA
PENNSYLVANIA SEDGE
DESCHAMPSIA CESPITOSA DT2 TUFTED HAIR GRASS EURYBIA MACROPHYLLA BIGLEAF ASTER KOFLERIA MACRANTHA PRAIRIE JUNEGRASS SPOROBOLUS HETEROLEPIS PRAIRIE DROPSEED SYMPHYOTRICHUM OBLONGIFOLIUM 'OCTOBER OCTOBER SKIES FALL ASTER PERENNIAL PLANTING MIX 1: FEATURE PLANTING RUDBECKIA HIRTA BLACK-EYED SUSAN AGASTACHE X `BLUE FORTUNE' BLUE FORTUNE ANISE HYSSOP ALLIUM STELLATUM PRAIRIE ONION SPOROBOLUS HETEROLEPIS SH3

PRAIRIE DROPSEED SYMPHYOTRICHUM NOVAE-ANGLIAE 'PURPLE DOME'

NEW ENGLAND ASTER



CITY OF SAINT PETER 227 South Front Street Saint Peter, MN 56082 p: 507.934.4840

DF/

DAMON FARBER LANDSCAPE ARCHITECTS

310 South 4th Avenue, Suite 7050 Minneapolis, MN 55415 p: 612,332,7522



BOLTON & MENK 1960 PREMIER DRIVE MANKATO, MN 56001-5900 p: 507.625.4171

507.625.4171

NELSON-RUDIE & ASSOCIATES 9100 49TH AVE NORTH MINNEAPOLIS, MN 55428 612,669,4385

> 100% CONSTRUCTION DRAWINGS

GORMAN PARK

ST. PETER, MINNESOTA

I hereby certify that this document was prepared by me or under my direct supervision and that I am a duly licensed Landscape Architect under the laws of the State of Minnesota.

Registration#

REVISION

 12/24/2024

 Signature
 Date


 100% CD SET
 12/24/2024

 DF/ Project #
 22-150

 Scale
 PER SHEET

 Drawn/Checked
 AG / RP / JR / JM

SITE UNDERSTORY PLANTING -PLAN B

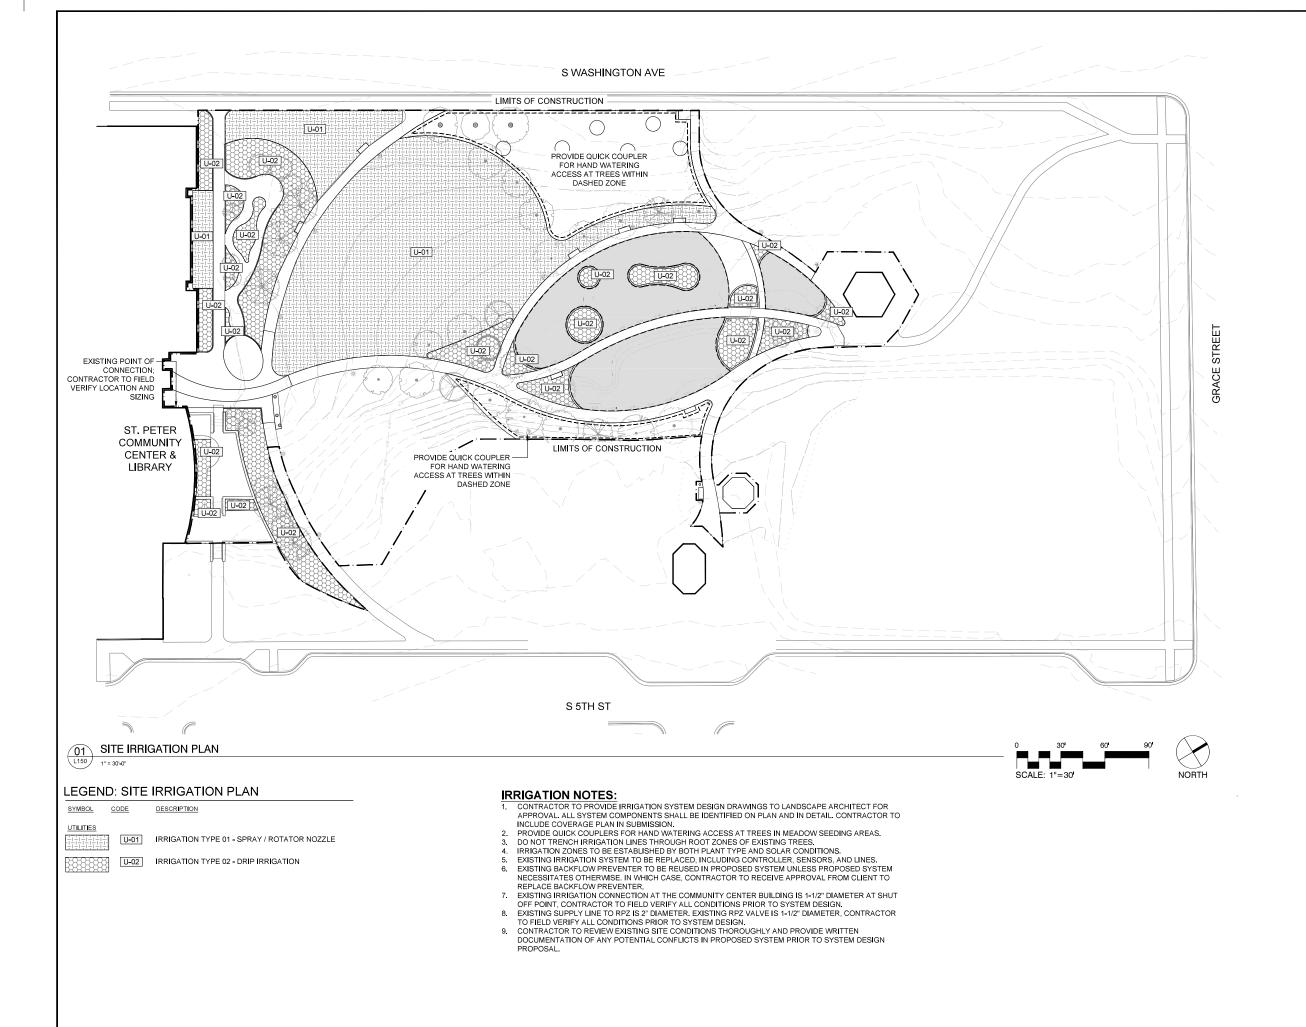



DF/

DAMON FARBER LANDSCAPE ARCHITECTS

310 South 4th Avenue, Suite 7050 Minneapolis, MN 55415 p: 612,332,7522



BOLTON & MENK 1960 PREMIER DRIVE MANKATO, MN 56001-5900 p: 507.625.4171

LELSON-RUDIE

NELSON-RUDIE & ASSOCIATES 9100 49TH AVE NORTH MINNEAPOLIS, MN 55428 612.669.4385

> 100% CONSTRUCTION DRAWINGS


GORMAN PARK

ST. PETER, MINNESOTA

I hereby certify that this document was prepared by me or under my direct supervision and that I am a duly licensed Landscape Architect under the laws of the State of Minnesota.

Ton Office	12/24/20
Signature	Di
100% CD SET	12/24/20
DF/ Project #	22-1
Scale	PER SHE
Drawn/Checked	AG/RP/JR/
REVISION	

SITE IRRIGATION PLAN

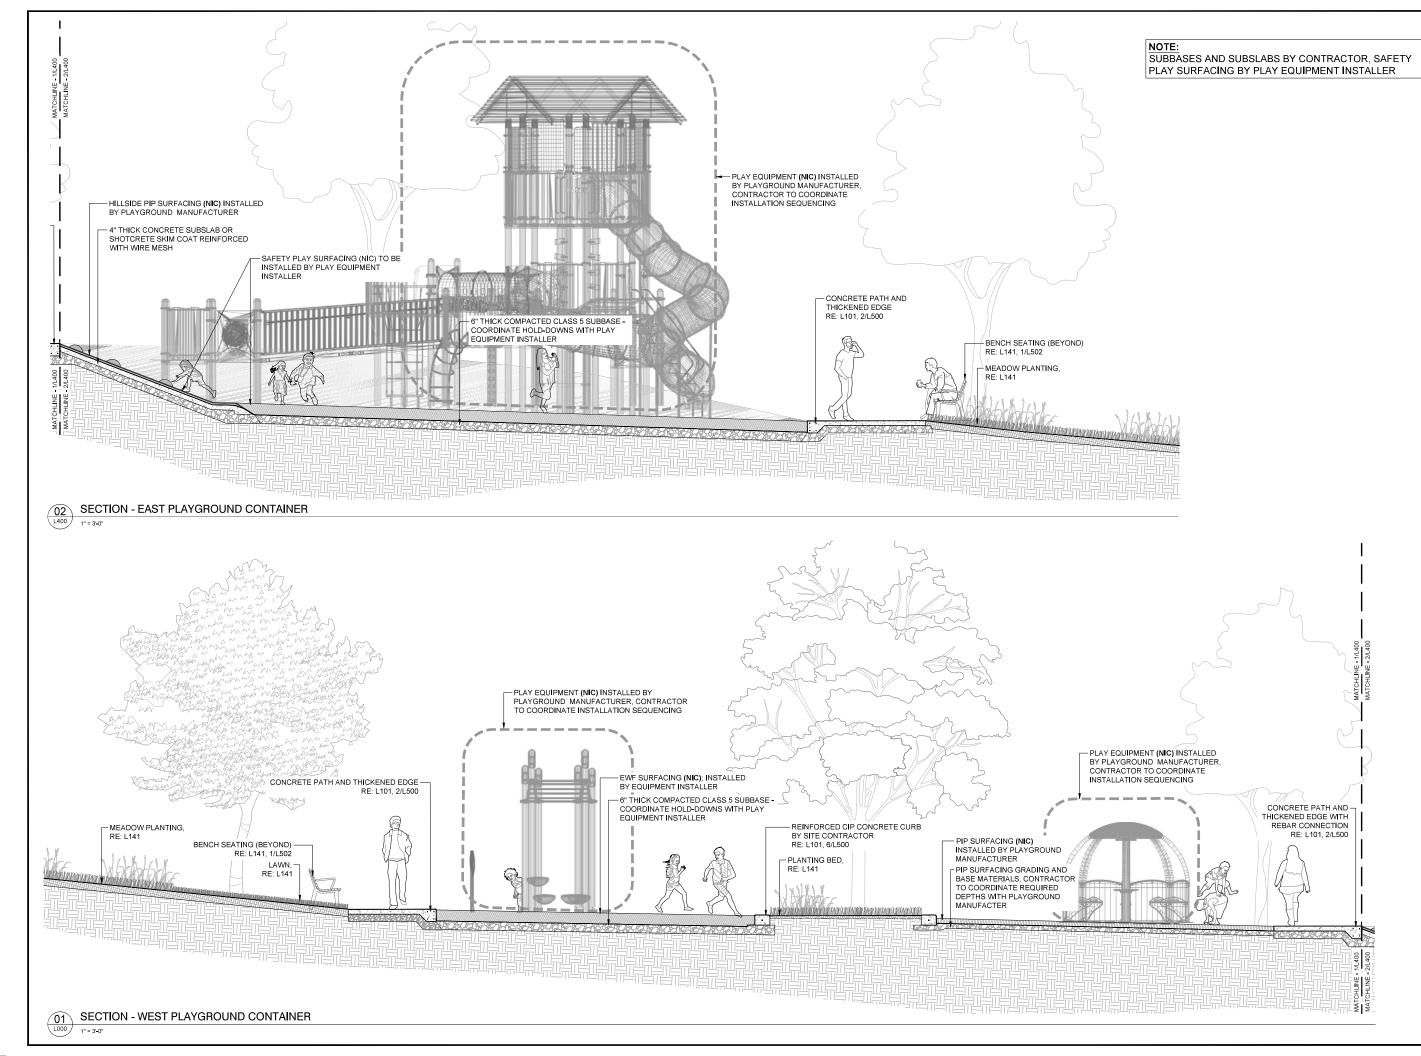



F/

DAMON FARBER LANDSCAPE ARCHITEC

310 South 4th Avenue, Suite 7050 Minneapolis, MN 55415 p: 612.332.7522



BOLTON & MENK 1960 PREMIER DRIVE MANKATO, MN 56001-5900 p: 507.625.4171

SON-RUDIE

NELSON-RUDIE & ASSOCIATES 9100 49TH AVE NORTH MINNEAPOLIS, MN 55428 612.669,4385

> 100% CONSTRUCTION DRAWINGS

GORMAN PARK

ST. PETER, MINNESOTA

Registration#

REVISION

I hereby certify that this document was prepared by me or under my direct supervision and that I am a duly licensed Landscape Architect under the laws of the State of Minnesota.

 12/24/2024

 Signature
 Date


 100% CD SET
 12/24/2024


 DF/ Project #
 22-150

 Scale
 PER SHEET

 Drawn/Checked
 AG / RP / JR / JM

SITE SECTION -PLAYGROUND CONTAINERS

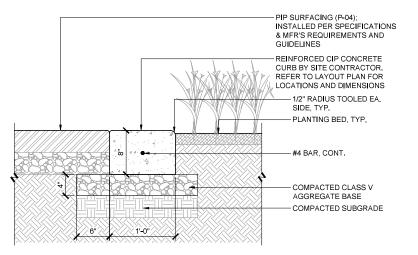

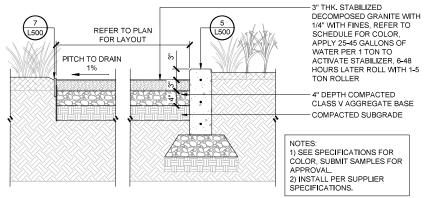

CURB TYPE 02 - 12" WIDTH CONC. CURB (CB-02)

P-22 150-120

PAVING TYPE 03 - DECOMPOSED GRANITE PAVING (P-03) 3

P-22 150-91

CITY OF

CITY OF SAINT PETER 227 South Front Street Saint Peter, MN 56082 p: 507.934.4840

DAMON FARBER LANDSCAPE ARCHITECTS

310 South 4th Avenue, Suite 7050

NELSON-RUDIE & ASSOCIATES

100% CONSTRUCTION

DRAWINGS

GORMAN PARK ST. PETER, MINNESOTA

I hereby certify that this document was prepared by me or under my direct supervision and that I am a duly licensed Landscape Architect under the laws of the State of Minnesota.

BOLTON & MENK

Minneapolis, MN 55415

p: 612.332.7522

BOLTON & MENK

1960 PREMIER DRIVE MANKATO, MN 56001-5900 p: 507.625.4171

9100 49TH AVE NORTH

MINNEAPOLIS, MN 55428 612,669,4385

ADJACENT CONDITIONS VARY, REFER TO PLANS 1/2" RADIUS, TYP. (2) #4 REBAR, CONT. THICKENED CONC. EDGE SCHEDULE CONC MIX PER SPECIFICATIONS COMPACTED AGGREGATE COMPACTED SUBGRADE, SEE CIVIL P-01A - CONCRETE PAVING & P-02 DECORATIVE CONCRETE

ADJACENT CONDITION VARIES, REFER TO PLANS 1/2" RADIUS TOOLED EA. SIDE PLANTING BED, TYP. - CIP CONC. CURB – DOWEL EPOXY COATED REBAR – EXPANSION JOINT - COMPACTED CLASS V AGGREGATE BASE COMPACTED SUBGRADE

CURB TYPE 01 - 6" WIDTH CONC. CURB (CB-01)

AGGREGATE PER SPEC - GEOTEXTILE FABRIC, TYPE 2

- METAL EDGER WITH STAKE FINISHED GRADE VARIES-SEE PLAN, HOLD 1" BELOW TOP OF EDGER

PLANTING AREA- SEE PLANTING

¾6" METAL EDGER W/ STAKE

HOLD FINISHED GRADE 1"

P-22 150-23

PAVING TYPE 01A & 01B- CONCRETE PAVING & THICKENED EDGE (P-01A, P-01B)

100% CD SET 12/24/2024 DF/ Project # 22-150 Scale PER SHEET Drawn/Checked AG/RP/JR/JN

REVISION

SITE DETAILS

L500

GAGA BALL FENCE; INSTALLED PER MFR 'S INSTRUCTIONS 9" MIN. DEPTH ENGINEERED WOOD FIBER SURFACING (E.W.F.), REFER TO SPECS; E.W.F. MULCH SHALL MEET ASTM F1292-99 FOR IMPACT ABSORPTION AND ASTM F1951 FOR WHEELCHAIR MANEUVERABILITY, PROVIDE CERTIFICATE OF COMPLIANCE - ADJACENT TURF -CUT SUBGRADE AT ANGLE -PROVIDE 'SPADED EDGE' NON-WOVEN GEOTEXTILE FABRIC FREE DRAINING AGGREGATE BASE, REFER TO CIVIL

TYPICAL CONCRETE PAVING PREMOLDED EXPANSION JOINT THE DEPTH OF SLAB: MAKE FILLER PER SPECIFICATIONS ALL SAW CUTS WITHIN 12 HR. OF CONCRETE POUR -1/4" THICK CUT TYPICAL EDGE, FORM AT 90 DEGREES TO APPEAR SIM. TO CONTROL JOINT EDGE EXPANSION JOINT TO OCCUR 60' O.C. MAX. AND AT CONSTRUCTION TYPICAL SAWCUT CONTROL JOINT JOINTS, RAMPS, WALLS, AND OTHER VERTICAL OBSTRUCTIONS. REFER TO PLAN FOR LOCATIONS

TYPICAL EXPANSION JOINT - ENLARGED

PAVING TYPE 06 - EWF SURFACING (P-06) AT GAGA BALL PIT 1 1/2" = 1'-0"

P-22 150-94

BELOW EDGER- SEE PLÂN FOR EDGE CONDITION - ADJACENT CONDITIONS VARY, REFER TO PLANS EDGING TYPE 01 - STEEL EDGER (ED-01) P-22 150-89

DETAIL - MINERAL MULCH MAINTENANCE STRIP (MM-01)


1' - 6". TYP.

VARIES: BUILDING FACE OR CONC CURB

໌8`


DETAIL - TYPICAL CONCRETE JOINTING


- **GENERAL NOTES:**1. ALL BLOCKS TO BE INSTALLED STABLE AND SECURELY AND SHALL NOT WOBBLE OR MOVE.
- 2. REFER TO PLANS FOR WALL LAYOUT
 3. WOOD SLAT BENCH TOPS TO BE INSTALLED DURING A LATER DATE, REFER TO PLANS FOR WOOD
- SLAT BENCH TOP LOCATIONS.

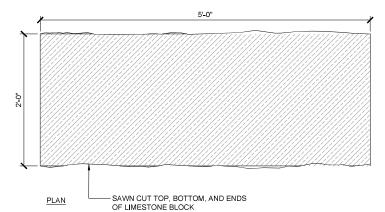


- NOTES:

 1. MEETS ADA REGULATIONS.
- OPTIONAL STAINLESS STEEL SURFACE CARRIER RECOMMENDED.
 INSTALLATION TO BE COMPLETED IN ACCORDANCE WITH MANUFACTURER'S.
- 4 DO NOT SCALE DRAWING
- THIS DRAWING IS INTENDED FOR USE BY ARCHITECTS, ENGINEERS,
 CONTRACTORS, CONSULTANTS AND DESIGN PROFESSIONALS FOR PLANNING
 PURPOSES ONLY. THIS DRAWING MAY NOT BE USED FOR CONSTRUCTION.
- ALL INFORMATION CONTAINED HEREIN WAS CURRENT AT THE TIME OF DEVELOPMENT BUT MUST BE REVIEWED AND APPROVED BY THE PRODUCT MANUFACTURER TO BE CONSIDERED ACCURATE.
 7. CONTRACTOR'S NOTE: FOR PRODUCT AND COMPANY INFORMATION VISIT
- www.CADdetails.com/info AND ENTER REFERENCE NUMBER 3354-1.5.

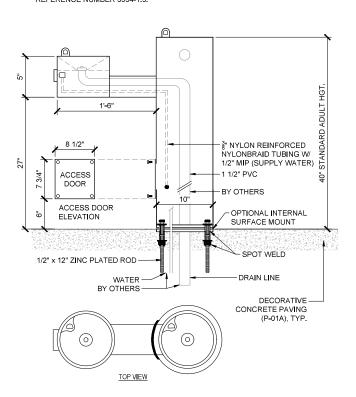

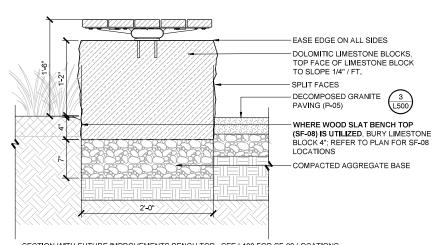

 $\underline{\text{SECTION WITH FUTURE IMPROVEMENTS BENCH TOP-SEE L100 FOR SF-08 LOCATIONS}}$

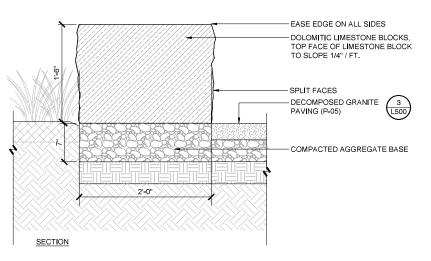

LIMESTONE BLOCK BENCH (SF-07)

CITY OF **SAINT** PETER

CITY OF SAINT PETER 227 South Front Street Saint Peter, MN 56082 p: 507.934.4840

DAMON FARBER LANDSCAFE ARCHITECTS

310 South 4th Avenue, Suite 7050 Minneapolis, MN 55415 p: 612.332.7522



BOLTON & MENK 1960 PREMIER DRIVE MANKATO, MN 56001-5900 p: 507.625.4171

NELSON-RUDIE & ASSOCIATES 9100 49TH AVE NORTH MINNEAPOLIS, MN 55428 612,669,4385

> 100% CONSTRUCTION DRAWINGS

GORMAN PARK

ST. PETER, MINNESOTA

I hereby certify that this document was prepared by me or under my direct supervision and that I am a duly licensed Landscape Architect under the laws of the State of Minnesota.

Registration#

100% CD SET	12/24/202
DF/ Project #	22-15
Scale	PER SHEE
Drawn/Checked	AG/RP/JR/J
REVISION	


SITE DETAILS

L501


P-22 150-121


1 1/2" = 1'-0"


DETAIL - SURFACE MOUNT DRINKING FOUNTAIN (SF-09)

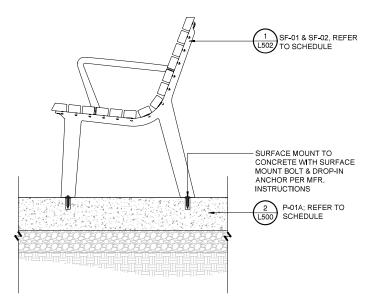



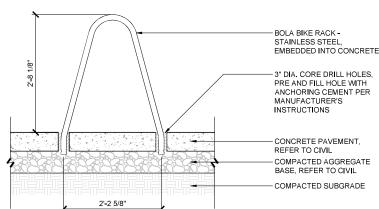

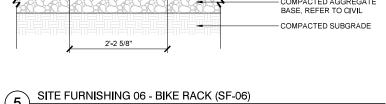

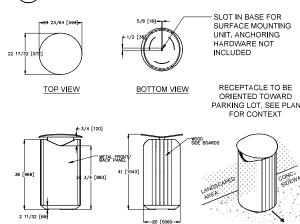

PRODUCT OF LANDSCAPE FORMS GENERATION 50 - SIDE OPENING RECEPTACLE


ANCHORING HARDWARE NOT

P-22 150-13

SEE SPECIFICATION FOR FULL PRODUCT INFORMATION


PROCEDURE FOR SURFACE


- PLACE THE UNIT IN THE DESIRED POSITION. OPEN
- DRILLING HOLE.
 DRILL HOLE AT MARKED LOCATION ACCORDING
- INSTRUCTIONS.

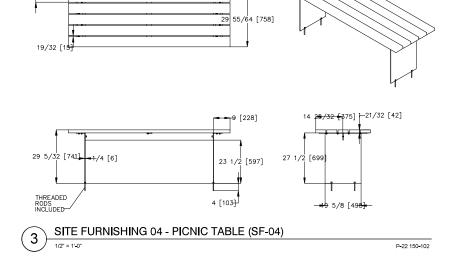


88 3/16 [2240]


5-1/2 [14

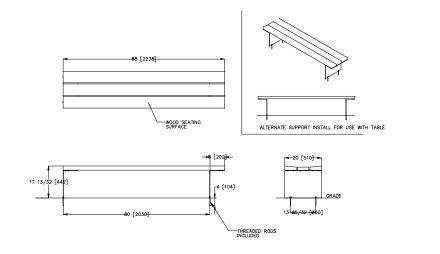

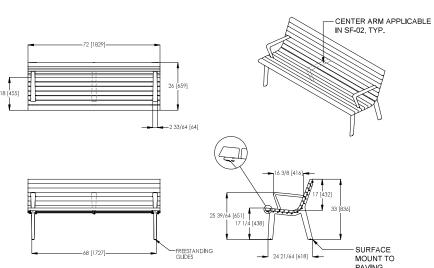


PAVING BELOW SITE FURNISHING 01 & 02 - 6' BACKED BENCH (SF-01 & SF-02)

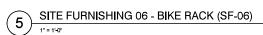

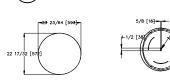

PARKING LOT, SEE PLAN

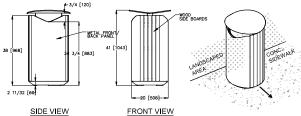

SITE FURNISHING 05 - RECEPTACLE (SF-05)

MOUNTED INSTALLATION

- THE LID TO CHECK CLEARANCE.
 REMOVE THE LINER AND MARK ANCHOR
- LOCATION THROUGH THE HOLE IN THE BASE. MOVE THE UNIT TO ALLOW ACCESS FOR THE
- TO ANCHOR MANUFACTURER'S SPECIFICATION

 5. COMPLETE THE ANCHOR INSTALLATION
- ACCORDING TO THE ANCHOR MANUFACTURER'S



CITY OF SAINT PETER 227 South Front Street Saint Peter, MN 56082 p: 507.934.4840

DAMON FARBER LANDSCAPE ARCHITECTS

310 South 4th Avenue, Suite 7050 Minneapolis, MN 55415 p: 612.332.7522



BOLTON & MENK 1960 PREMIER DRIVE MANKATO, MN 56001-5900 p: 507.625.4171

NELSON-RUDIE & ASSOCIATES 9100 49TH AVE NORTH MINNEAPOLIS, MN 55428 612,669,4385

> 100% CONSTRUCTION DRAWINGS

GORMAN PARK

Registration#

ST. PETER, MINNESOTA

I hereby certify that this document was prepared by me or under my direct supervision and that I am a duly licensed Landscape Architect under the laws of the State of Minnesota.

Ton Utilla	12/24/2024
Signature	Date
100% CD SET	12/24/2024
DF/ Project #	22-150
Scale	PER SHEET
Drawn/Checked	AG/RP/JR/JN
REVISION	-

SITE DETAILS

L502

DETAIL - SHADE PAVILLION V-COLUMNS & FOOTING

2'-0"

NOTES:

1. REFER TO SHEET L503 FOR PAVILION DETAILS.
2. CONTRACTOR TO PRODUCE AND SUBMIT ENGINEERED SHOP DRAWINGS STAMPED BY A LICENSED

6" X 6" SQUARE TUBE STEEL

2" X 6" THERMALLY MODIFIED ASH LOUVERED SLATS; SLATS LOUVERED AT APPROX. 40 DEGREE ANGLE; FASTEN LOUVERED SLATS TO SUPPORT GRID WITH LAG

SECURE V-COLUMNS TO CONCRETE FOOTING THROUGH 1/2" STEEL BASE PLATE - 12" X 6" SQUARE TUBE STEEL

SUPPORT GRID; GALVANIZED

TOP GUSSETS; GALVANIZED, POWDER COATED STEEL;

- 8" X 8 ¹/₄" WALL SQUARE TUBE V-COLUMNS WITH BOTTOM AND

P-22 150-116

AND POWDERCOATED

FRAME BEYOND

BOLTS, TYP.

ANGLES VARY

ELECTRICAL ACCESS PANEL REFER TO ELECTRICAL

8" X 8 1/4" WALL SQUARE TUBE V-COLUMNS WITH BOTTOM AND TOP GUSSETS; GALVANIZED, POWDER

COATED STEEL; ANGLES VARY

SECURE V-COLUMNS TO

2' DIA, CONCRETE FOOTING

ADJACENT PAVING, REFER TO PLAN

EXPANSION JOINT, TYP

REINFORCED CONCRETE

FOOTING; FOOTING DEPTH AND DESIGN BY STRUCTURAL

GUSSET PLATE COLUMN SUPPORT

THICKENED CONCRETE EDGE (P-01B)

CONCRETE FOOTING THROUGH 1/2" STEEL BASE PLATE

STRUCTURAL ENGINEER FOR APPROVAL BY LANDSCAPE ARCHITECT PRIOR TO FABRICATION.

DETAIL - SHADE PAVILION V-COLUMN & SUPPORT GRID

2. CONTRACTOR TO PRODUCE AND SUBMIT ENGINEERED SHOP DRAWINGS STAMPED BY A LICENSED STRUCTURAL ENGINEER FOR APPROVAL BY

3. THICKENED CONCRETE EDGE LOCATION TO BE COORDINATED BETWEEN G.C. AND PAVILION FABRICATOR THROUGHOUT SHOP DRAWING PROCESS.

GUSSET PLATE

COLUMN SUPPORT

1 1/2" = 1'-0"

REFER TO SHEET L503 FOR PAVILION DETAILS

LANDSCAPE ARCHITECT PRIOR TO FABRICATION

໌8ີ

ENGINEER

4 P-22 150-115


P-22 150-21


SITE FURNISHING 03 - PICNIC BENCH (SF-03)

P-22 150-48



DESIGN INTENT

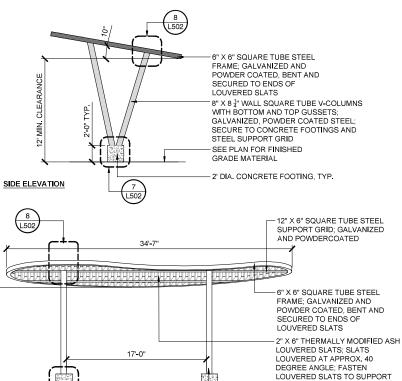

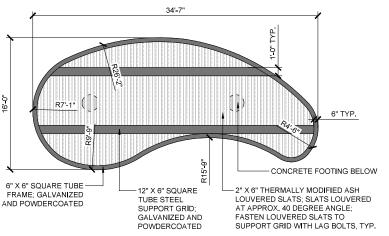

- 2' DIA. CONCRETE FOOTING, TYP.

PLAN VIEW

L502

FRONT ELEVATION


DESIGN INTENT


GENERAL SHADE PAVILION NOTES:

1. CONTRACTOR TO PRODUCE AND SUBMIT ENGINEERED SHOP DRAWINGS STAMPED BY A LICENSED STRUCTURAL ENGINEER FOR APPROVAL BY LANDSCAPE ARCHITECT PRIOR TO FABRICATION.

2. SHOP DRAWINGS TO INCLUDE TYPES OF METAL AND WOOD COMPONENTS OF EACH SHADE PAVILION AND LIST THE FASTENER AND WELD TYPES NEEDED TO ASSEMBLE

3 SHOP DRAWINGS TO INCLUDE CORROSION RESISTANT FINISHES TO BE APPLIED TO METAL COMPONENTS.

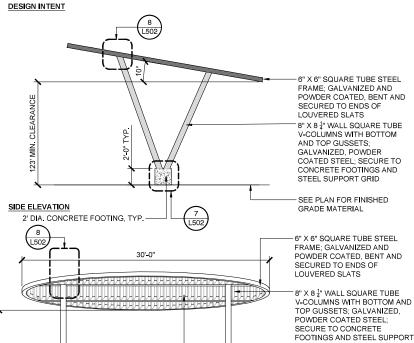

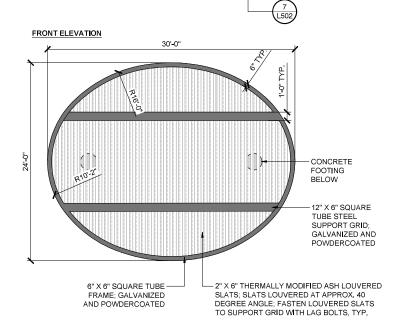

PLAN VIEW

DETAIL - SITE AMENITY TYPE 02 - PLAYGROUND SHADE PAVILION (AM-02)

P-22 150-113

GRID WITH LAG BOLTS, TYP.

8" X 8 1/4" WALL SQUARE TUBE

V-COLUMNS WITH BOTTOM AND TOP GUSSETS;

GALVANIZED, POWDER COATED STEEL; SECURE TO

CONCRETE FOOTINGS AND STEEL SUPPORT GRID

DETAIL - SITE AMENITY TYPE 01 - COMMUNITY CENTER SHADE PAVILION (AM-01)

CITY OF **SAINT** PETER

CITY OF SAINT PETER 227 South Front Street Saint Peter, MN 56082 p: 507.934.4840

DAMON FARBER LANDSCAPE ARCHITECTS

310 South 4th Avenue, Suite 7050 Minneapolis, MN 55415 p: 612.332.7522



BOLTON & MENK 1960 PREMIER DRIVE MANKATO, MN 56001-5900 p: 507.625.4171

NELSON-RUDIE & ASSOCIATES 9100 49TH AVE NORTH MINNEAPOLIS, MN 55428 612,669,4385

> 100% CONSTRUCTION DRAWINGS

GORMAN PARK

2" X 6" THERMALLY MODIFIED ASH

LOUVERED SLATS TO SUPPORT GRID WITH LAG BOLTS, TYP.

LOUVERED SLATS; SLATS LOUVERED AT APPROX. 40

DEGREE ANGLE: FASTEN


—— 2' DIA. CONCRETE FOOTING, TYP.


ST. PETER, MINNESOTA


I hereby certify that this document was prepared by me or under my direct supervision and that I am a duly licensed Landscape Architect under the laws of the State of Minnesota.


Registration# 100% CD SET 12/24/2024 DF/ Project # 22-150 PER SHEET Drawn/Checked AG / RP / JR / JN REVISION

SITE DETAILS

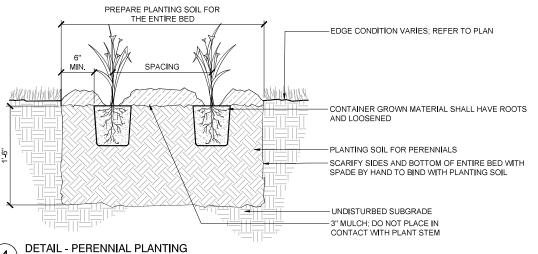

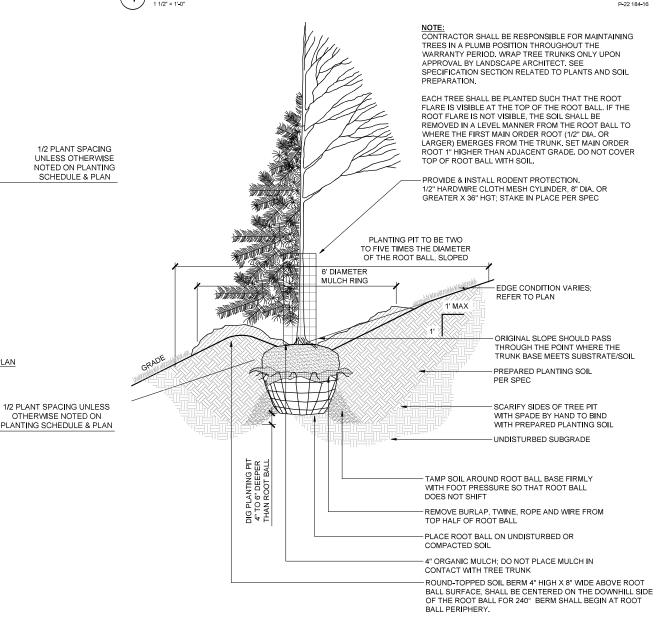

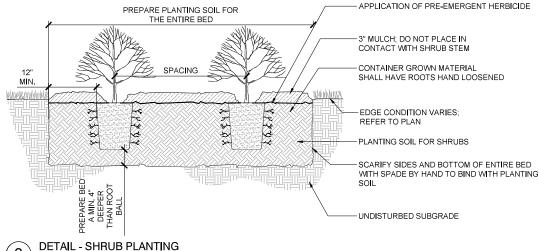

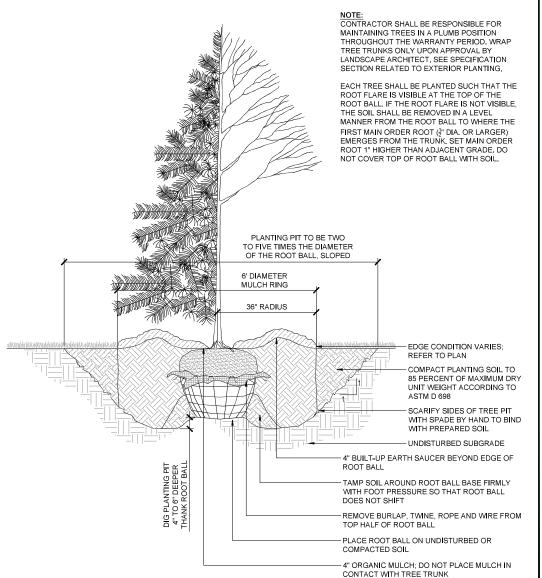

TREE PLANTING DETAIL

CITY OF **SAINT** PETER

CITY OF SAINT PETER 227 South Front Street Saint Peter, MN 56082 p: 507.934.4840

DAMON FARBER LANDSCAPE ARCHITECTS

310 South 4th Avenue, Suite 7050 Minneapolis, MN 55415 p: 612.332.7522



BOLTON & MENK 1960 PREMIER DRIVE MANKATO, MN 56001-5900 p: 507.625.4171

P-22 184-14

NELSON-RUDIE & ASSOCIATES 9100 49TH AVE NORTH MINNEAPOLIS, MN 55428 612,669,4385

> 100% CONSTRUCTION DRAWINGS

GORMAN PARK

ST. PETER, MINNESOTA

I hereby certify that this document was prepared by me or under my direct supervision and that I am a duly licensed Landscape Architect under the laws of the State of Minnesota.

Registration 100% CD SET 12/24/2024 DF/ Project # 22-150 PER SHEET Drawn/Checke AG / RP / JR / JN REVISION

> **PLANTING DETAILS**

P-22 184-10

DETAIL - PLANT SPACING 5

GRID SPACING LAYOUT PLAN

NOTE: REFER TO PLANTING SCHEDULE

TRIANGULAR SPACING LAYOUT PLAN

PLANT SPACING.

1/2 PLANT SPACING

1/2 PLANT SPACING UNLESS

OTHERWISE NOTED ON

P-22 184-12

DETAIL - TREE PLANTING ON SLOPE 5% (20:1) TO 50% (2:1)

	ELECTRICAL SYMBOLS											
	LIGHTING	SYMBOLS		SYSTEM	MS SYMBOLS	SYSTEMS SYMBOLS			POWER SYMBOLS			
MNT HT	SYMBOL	DESCRIPTION	MNT HT	SYMBOL	DESCRIPTION	MNT HT	SYMBOL	DESCRIPTION	MNT HT	SYMBOL	DESCRIPTION	
			80° 80° 48° 54° 54° 54° 54° 54° 54° 54° 54° 54° 54			MNT HT 18" 18" 18" 18" 18" 18" 18" 18" 18" 18"			MNT HT 18" 18" 18" 18" 18" 18" 18" 18" 18" 18"		DESCRIPTION RECEPTACLE - SIMPLEX RECEPTACLE - DUPLEX RECEPTACLE - DUPLEX RECEPTACLE - CUADPLEX RECEPTACLE - CELING MOUNT RECEPTACLE - DUPLEX EMERGENCY RECEPTACLE - DUPLEX EMERGENCY RECEPTACLE - SWITCHED COMPUTER RECEPTACLE - DUPLEX COMPUTER RECEPTACLE - DUPLEX CELING MOUNT COMPUTER RECEPTACLE - DUPLEX CELING MOUNT COMPUTER RECEPTACLE - DUPLEX FLOOR RECEPTACLE - SPECIAL PURPOSE - SEE DWGS RECEPTACLE - SPECIAL PURPOSE - SEE DWGS JUNCTION BOX - WALL JUNCTION BOX - WALL JUNCTION BOX - FLOOR MOTOR DISCONNECT SWITCH FUSED DISCONNECT SWITCH STARTER PUSHBUTTON MOTOR STARTER SWITCH THERMOSTAT COMBINATION STARTER-DISCONNECT CONTACTOR GROUND	
			C	D ≰ ET	EMERGENCY TELEPHONE - BOLLARD					ATS	METER AUTOMITIC TRANSFER SWITCH LTG/REC PANELBOARD DISTRIBUTION PANELBOARD	

	LIGHT FIXTURE SCHEDULE										
TYPE	MANUFACTURER	CATALOG NUMBER	LAMPS	VOLTAGE	APPARENT LOAD	MOUNTING TYPE	DESCRIPTION	NOTE			
A1	ACUITY-HALOPHANE	GVD3 P20 30K MVOLT MS GL5 BK ST TBK PR / AP20-14.5 F S 1 1 / C11242NG4VP	3000K LED/ 5394 LUMEN	120 V	39 VA	SURFACE	TRADITIONAL ACORN PEDESTRIAN LAMP WITH FROSTED LENS, 3000K, WITH 14' - 6" FLUTED POLE AND FLUSH GRADE BASE				
B1	ACUITY-HALOPHANE	PSLED P4 40K MVOLT 65 KM BKSPD WL 23 PSLEDFV BKSDP	4000K LED/ 17600 LUMEN	120 V	123 VA	POLE	WIDE PATTERN SMALL LED FLLOD WITH FULL VISOR, BLACK FINISH. PROVIDE DUAL MOUNT POLE TOP ON EXISTING POLE.				

ELEC	ELECTRICAL SHEET LIST								
E000	ELECTRICAL TITLE SHEET & SCHEDULES								
E001	ELECTRICAL SITE PLAN								
LPC1	LIGHITNG PHOTOMETRIC CALCULATIONS								

LP-1	E	XIS	T	INC	;						
PARK RESTROOM BLDG SURFACE MOUNT TOP FEED INTEGRATED SHORT CIRCUIT CURRE (IER) - 10,000 RMS	IT RATI	NG		120/240 VG 200A BUS 200A MCB SUPPLIED			3500		GROUND BUS	1	
DESCRIPTION	KVA			BREAKER AMPIPOLE	,		v	BREAKER AMPIPOLE	TYPE QTY	KVA	DESCRIPTION
STORAGE LIGHTS RESTROOM LIGHTS OUTSIDE LIGHTS	0,5		111	20/1 20/1 20/1	3 6	BA	4 6	20/1 20/1 20/1	R R	0,2	STORAGE RCPT RESTROOM GECLECHT DUTSIDE GECLECHT
LCP, TIME CLOCK FLUSH SELONIOD OUTSIDE POLE LIGHT	0.6		PN	20/1	7 9	BAR	8 10	20/f 20/f	PN PN	1	WOMENS HAND DRYER MENS HAND DRYER DUTSIDE POLE LIGHTS
MIDWEST BOX	3,4		R	50/2	13 15	AB	14 16	20/f 90/Z	L NV	1 2	OUTSIDE POLE LIGHTS FEED TO GAZEBO
MIDWEST BOX NORTH MIDWEST BOX NORTH	0.2		RR	20/1	17	B	18	36/2	PW	2.5	HEATER
FUTURE SPLASH POOL FUTURE POOL CONTROL	0		PN	40/2	21 23 25	BA	22 24 26		PN SC.	2,5	SPACE
PAVILIAN RCPTS SPACE	0.7		R SC	20/1	27 29	BA	28 30		SC SC		SPACE SPACE
SPACE SPACE SPACE			3C 3C		31 33 35	BAB	32 34 36		SC SC		SPACE SPACE SPACE
SPACE EFACE SPACE			3C 5C 5C		97 49 41	ABA	38 40 42		80 80 80		SPACE SPACE SPACE
Connected Load	KVA	AMPS		Type	KVA		Factor	KVA			
Phase A Phase B Total Average *Spares not included	12.8 13.8 0.0 26.6	115.0		PN PW MN MNI MS	4,0 8,7 13,9 0,0 0,0 0,0		x 1.26 x 0.5 = x 1 = x 1 = x 1 = x 1 = x 1 =		*100% of 1st		us 50% of remainder.
				MW KT Total	0.0		x 1 = x 0.65	0.0	110.8 27.6	Total C	Connected Amps Demand KVA

	LIGHITNG CONTROL SCHEDULE (LCP)							
ZONE	ZONE DESCRIPTION	ZONE LOCATION	LIGHT SOURCE	DMMNG	TIME OF DAY CONTROL	CONTROL	NOTES	
A	PATHWAY LIGHTS	PARK	LED	NO:	140	YES		
- 0	PEATURE LIGHTS	PAVILION	LED	NO:	YES	YES		

LIGHTING CONTROL NOTES:

PROVIDE LIGHTING CONTROLS THAT FULFILL THE INTENT AS DESCRIBED BELOW, ACCEPTABLE MANUFACTURERS INCLUDE ACUITY FRESCO, CRESTRON, LEVITON, AND ILC.

PROVIDE CENTRALIZED LIGHTING CONTROL SYSTEM WITH INPUT FROM USER PROGRAMMINS, PHOTOCELL CONTROL, AND LOCAL OVERNDE CONTROLS THAT ARE PROTECTED BY KEY OR PASSWORD. PROVIDE TOUCH SCREEN LIGHTING CONTROL LERS FOR LOCAL OVERRIDE AND LIGHTING CONTROL PROGRAMMINS, SHALL BE PROGRAMMED SUCH THAT ALL LIGHTING IS QUICKLY ACCESSIBLE.

PROVIDE ALL PARTS AND LABOR TO FORM A COMPLETE LIGHTING CONTROL SYSTEM EQUIVALENT TO AN ACUITY FRESCO LIGHTING CONTROL SYSTEM AND ALL ASSOCIATED LIGHTING PANELS AND DEVICES.

CONTROL POWER FOR LCP-1 SHALL BE PROVIDED BY CIRCUIT LP-1/7.



CITY OF SAINT PETER 227 South Front Street Saint Peter, MN 56082 p: 507.934.4840

DF/

DAMON FARBER LANDSCAPE ARCHITECTS

310 South 4th Avenue, Suite 7050 Minneapolis, MN 55415 p: 612.332.7522

BOLTON & MENK 1960 PREMIER DRIVE MANKATO, MN 56001-5900 p: 507.625.4171

NELSON-RUDIE NELSON-RUDIE & ASSOCIATES
9100 49TH AVE NORTH
MINNEAPOLIS, MN 55428
612.669.4385

100% CONSTRUCTION DRAWINGS

GORMAN PARK

ST. PETER, MINNESOTA

I hereby certify that this plan, specification, or report was prepared by me or under my direct supervision and that I am a duly Licensed Professional Engineer under the laws of the state of Minnesota.

JEFFREY A. PIEHL

Registration#	43926
Signature	12/24/2024 Date
100% CD SET	12/24/2024
DF/ Project #	24-03
Scale	PER SHEET
Drawn/Checked	DJH / JAP
REVISION	

ELECTRICAL TITLE SHEET & SCHEDULES

E000





- A. THESE PLANS WERE PREPARED USING EXISTING CONSTRUCTION DOCUMENTS AND CASUAL FIELD OBSERVATION. THE CONTRACTOR SHALL FIELD VERIFY ALL CONDITIONS ON SITE AND NOTIFY THE ARCHITECT AND ENGINEER OF ANY DISCREPANCIES PRIOR TO COMMENCING WORK.
- B. THE CONTRACTOR SHALL MAINTAIN SERVICE TO ALL DOWNSTREAM DEVICES AND EQUIPMENT AFFECTED BY REMODELING. PROVIDE NEW CONDUITS, WIRING AND CONNECTIONS AS REQUIRED.
- CEILINGS REQUIRED FOR INSTALLATION OF NEW WORK OR REMOVAL OF EXISTING WORK SHALL BE PROVIDED BY ARCHITECTURAL SPECIFICATIONS.
- D. ALL FACEPLATES SHALL BE STEEL. PROVIDE COVER-PLATES FOR ALL ABANDONED BOXES.
- E. EQUIPMENT BY OTHER TRADES ARE SHOWN WHERE AN ELECTRICAL CONNECTION IS NECESSARY. REFERENCE MECHANICAL, PLUMBING, AND REFRIGERATION PLANS FOR EXACT LOCATIONS OF EQUIPMENT.
- F. SOME OF THE DEVICES TO BE DEMOLISHED ARE IDENTIFIED BY NOTE. THESE NOTES DO NOT COVER THE EXTENT OF THE DEMOLITION. COORDINATE WITH OTHER TRADES TO PROVIDE DEMOLITION OF CONDUIT AND WIRING OF OTHER SYSTEMS. REMOVE OUT THE CONNECTIONS AND PROVIDE BLANK COVER-PLATES AS NEEDED.
- G. SEE STRUCTURAL DRAWINGS FOR SPECIFIC ALLOWABLE LOCATIONS TO CORE DRILL HOLES THROUGH EXISTING OR NEW WALLS.
- H. DEMOLISHED EQUIPMENT ELECTRICAL CONNECTIONS SHALL BE REMOVED BACK TO THE SOURCE AND THE BREAKERS MARKED 'SPARE'.
- ALL LIGHTING FIXTURE PROPOSED EQUALS SHALL BE SUBMITTED FOR APPROVAL TW0 (2) WEEKS BEFORE BIDS ARE DUE.
- LIGHTING CIRCUIT AHEAD OF ANY SWITCHING.
- PANELS INDICATED AND REPOUTE CIRCUITING AS

KEY NOTES

- (2) MAKE PROVISIONS AT THIS POLE FOR CONNECTION TO ADDITIONAL PATH LIGHTING TO BE ADDED IN BID PACKAGE #2.
- UTILIZE EXISTING CIRCUITS FROM DEMOLISHED PEDESTAL FEED, PROVIDE NEW BREAKERS AND WIRE FROM EXISTING PANEL TO NEW RECEPTACLE LOCATIONS, UTILIZE EXISTING CONDUIT AND EXTEND TO NEW LOCATION WITH MINIMUM 24* BURIAL DEPTH. COORDINATE COUNDUIT ROUTING WITH PAVILION COLUMN SUPPORT AND BASE.
- EXISTING IN-GRADE LIGHTING TO BE REMOVED.
- (5) EXISTING PEDESTAL POWER BOX TO BE REMOVED.
- 6 EXISTING FLOOD LIGHT TO BE REMOVED AND REPLACED ANSI INING FLOOD LIGHT TO BE REMOVED AND REPLACED.
 WITH DUAL LED FLOOD LIGHTS, PROVIDE TWIN MOUNT
 POLE TOP (HOLOPHANE BR19## SERIES OR SIMILAR)
 FOR MOUNTING THE NEW FLOOD LIGHTS. UTILIZE THE
 EXISTING CIRCUIT AND CONTROLS.



- C. CUTTING AND PATCHING OF EXISTING WALLS, FLOORS &

- J. CIRCUIT ALL EXIT SIGNS & EGRESS LIGHTING TO ROOM
- K. REFER TO SHEET E000 FOR ELECTRICAL CIRCUIT INFORMATION. EC TO VERIFY AVAILABLE SPARES IN
- L. ALL UNDERGROUND CONDUITS TO BE BURIED MINIMUM 2"-0" BELOW FINAL GRADE.
- (1) EXISTING 200 AMP 120/240V ELECTRICAL PANEL.
- (3) PROVIDE GFCI RECEPTACLE WITH WP WHILE IN-USE COVER MOUNTED TO STRUCTURE COLUMN AT 24" AFG. UTILIZE EXISTING CIRCUITS FROM DEMOLISHED



CITY OF SAINT PETER 227 South Front Street Saint Peter, MN 56082 p: 507.934.4840

DF/ DAMON FARBER LANDSCAFE ARCHITECTS

310 South 4th Avenue, Suite 7050 Minneapolis, MN 55415 p: 612.332.7522

BOLTON & MENK 1960 PREMIER DRIVE MANKATO, MN 56001-5900 p: 507.625.4171

MINNEAPOLIS, MN 55428 612.669.4385

NELSON-RUDIE & ASSOCIATES 9100 49TH AVE NORTH

> CONSTRUCTION DRAWINGS

GORMAN PARK

ST. PETER, MINNESOTA


I hereby certify that this plan, specification. or report was prepared by me or under my direct supervision and that I am a duly Licensed Professional Engineer under the laws of the state of Minnesota.

JEFFREY A. PIEHL

Am A. Dal	12/24/2024 Date
00% CD SET	12/24/2024
DF/ Project #	24-035
Scale	PER SHEET
Drawn/Checked	DJH / JAP
REVISION	<u>-</u>


ELECTRICAL SITE PLAN

E001

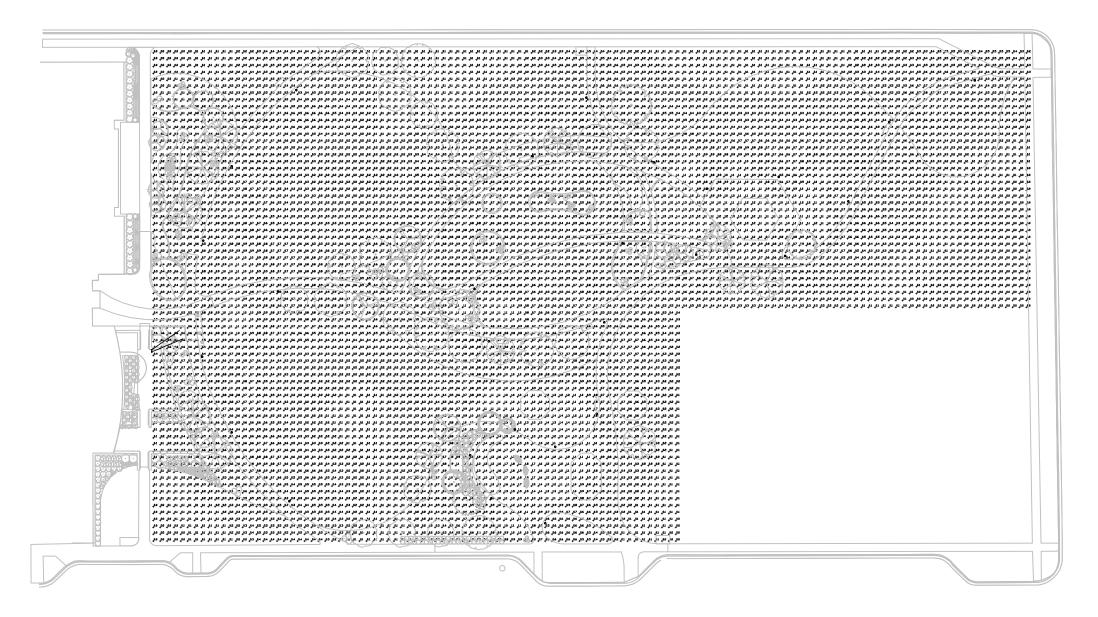

1 LIGHTING

LIGHTING PHOTOMETRIC PLAN

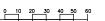



CITY OF SAINT PETER 227 South Front Street Saint Peter, MN 56082 p: 507.934.4840

DF/ DAMON FARBER LANDSCAFE ARCHITECTS

310 South 4th Avenue, Suite 7050 Minneapolis, MN 55415 p: 612.332.7522

BOLTON & MENK 1960 PREMIER DRIVE MANKATO, MN 56001-5900 p: 507.625.4171

NELSON-RUDIE NELSON-RUDIE & ASSOCIATES

9100 49TH AVE NORTH MINNEAPOLIS, MN 55428 612.669.4385

> 100% CONSTRUCTION DRAWINGS

GORMAN PARK

ST. PETER, MINNESOTA

I hereby certify that this plan, specification, or report was prepared by me or under my direct supervision and that I am a duly Licensed Professional Engineer under the laws of the state of Minnesota.

THERE SELLING	
Registration#	439
Signature A. Puff	12/24/20 Da
100% CD SET	12/24/20
DF/ Project #	24-0
Scale	PER SHE
Drawn/Checked	DJH / JA
REVISION	

LIGHTING PHOTOMETRIC CALCULATIONS

LPC1